

1270 64TH ST 1270 64TH ST EMERYVILLE, CA

PLANNING SUBMITTAL 06/07/2021

GENERAL NOTES

- SCOPE DOCUMENTS: THESE DRAWINGS INDICATE THE GENERAL SCOPE OF THE PROJECT IN TERMS OF THE OVERALL CONCEPT, THE DIMENSIONS OF THE BUILDING, THE MAJOR ARCHITECTURAL ELEMENTS AND THE TYPE OF STRUCTURAL, MECHANICAL, ELECTRICAL SYSTEMS, ON THE BASIS OF THE GENERAL SCOPE INDICATED OR DESCRIBED, THE CONTRACTOR SHALL FURNISH ALL ITEMS REQUIRED FOR THE PROPER EXECUTION AND COMPLETION OF THE WORK. APPROVAL BY THE CITY INSPECTOR DOES NOT CONSTITUTE AUTHORITY TO DEVIATE FROM THE PLANS AND SPECIFICATIONS
- THE FOLLOWING NOTES AND TYPICAL DETAILS APPLY TO ALL DRAWINGS UNLESS OTHERWISE NOTED, AND SHALL TAKE PRECEDENCE OVER THESE GENERAL NOTES. SEE ALSO NOTES, ABBREVIATIONS, DRAWING LEGENDS AND SYMBOLS, STRUCTURAL DRAWINGS.
- DRAWINGS INDICATE GENERAL AND TYPICAL DETAILS OF CONSTRUCTION. WHERE CONDITIONS ARE NOT SPECIFICALLY INDICATED BUT ARE OF SIMILAR CHARACTER TO DETAILS SHOWN, DETAILS OF CONSTRUCTION SHALL BE USED SUBJECT TO THE REVIEW AND APPROVAL OF THE ARCHITECT.

THE CONTRACTOR SHALL PERFORM IN A MANNER CONFORMING TO APPLICABLE REGULATIONS, AND REQUIREMENTS OF ALL GOVERNING AGENCIES AS WELL AS STANDARD INDUSTRY PRACTICES.

- RESPONSIBILITY. THE CONTRACTOR SHALL VERIFY ALL DIMENSIONS AND SITE CONDITIONS BEFORE STARTING WORK. SHOULD A DISCREPANCY APPEAR IN THE SPECIFICATIONS OR DRAWINGS, OR IN THE WORK DONE BY OTHERS FROM THE CONTRACT DOCUMENTS THAT AFFECT ANY WORK, NOTIFY THE ARCHITECT AND OWNER IN WRITING AT DINCE FOR INSTRUCTIONS TO PROCEED. IF THE CONTRACTOR PROCEEDS WITH THE WORK AFFECTED WITHOUT WRITTEN INSTRUCTIONS FROM THE ARCHITECT THE CONTRACTOR SHALL MAKE GOOD ANY RESULTING DAMAGE OR DEFECT TO THE ARCHITECT. THE CONTRACTOR SHALL MAKE GOOD ANY RESULTING OWNER. SHOULD A CONFLICT OCCUR IN OR BETWEEN THE DRAWINGS AND SPECIFICATIONS, OR WHERE DETAIL REFERENCES ON THE CONTRACTOR SHAVES HAVE BEEN OMNITTED, THE CONTRACTOR IS DEEMED TO HAVE ESTIMATED THE MOST EXPENSIVE MATERIAL AND CONSTRUCTION METHODS INVOLVED, UNLESS A WRITTEN DECISION FROM THE ARCHITECT / OWNER HAS BEEN OBTAINED WHICH DESCRIBES AN ALTERNATE METHOD AND/OR MATERIALS OR UNLESS THE ORIGINAL BID IS APPROPRIATELY QUALIFIED.
- THE CONTRACTOR SHALL CONFINE HIS/HER OPERATIONS ON THE SITE TO AREAS PERMITTED BY THE OWNER. THE JOB SITE SHALL BE MAINTAINED IN A CLEAN, ORDERLY CONDITION FREE OF DEBRIS AND LITTER, AND SHALL NOT BE UNREASONABLY ENCUMBERED WITH ANY MATERIALS OR EQUIPMENT. EACH SUBCONTRACTOR IMMEDIATELY UPON COMPLETION OF EACH PHASE OF HIS/HER WORK SHALL REMOVE ALL TRASH AND DEBRIS AS A RESULT OF HIS/HER OPERATION.
- ALL MATERIALS STORED ON THE SITE SHALL BE PROPERLY STACKED AND PROTECTED TO PREVENT DAMAGE AND DETERIORATION UNTIL USE. FAILURE TO PROTECT MATERIALS MAY BE CAUSE FOR REJECTION OF WORK
- PROVIDE ALL NECESSARY BLOCKING, BACKING AND FRAMING FOR LIGHT FIXTURES, ELECTRICAL UNITS, PANELS HVAC EQUIPMENT AND ALL OTHER ITEMS REQUIRING SAME.
- ALL MATERIALS SHALL BE HANDLED AND INSTALLED PER THE MANUFACTURER'S SPECIFICATIONS AND RECOMMENDATIONS
- STORAGE & DISPENSING OR USE OF ANY FLAMMABLE OR COMBUSTIBLE LIQUIDS, FLAMMABLE GASES AND HAZARDOUS CHEMICALS SHALL COMPLY WITH THE UNIFORM FIRE CODE REGULATIONS.
- NO MATERIALS SHALL BE STORED ON PUBLIC PROPERTY UNLESS AN ENCROACHMENT PERMIT IS FIRST OBTAINED FROM THE PUBLIC WORK DEPARTMENT.
- 10. THE CONTRACTOR SHALL DO ALL CUTTING, FITTING, OR PATCHING OF HIS/HER WORK THAT MAY BE REQUIRED TO MAKE ITS SEVERAL PARTS FIT TOGETHER PROPERLY AND SHALL NOT ENDANGER ANY OTHER WORK BY CUTTING, EXCAVATING, OR OTHERWISE ALTERING THE TOTAL WORK OR ANY PART OF IT. ALL PATCHING, REPAIRING, AND REPLACING OF MATERIALS AND SURFACES, CUT OR DAMAGED IN EXECUTION OF WORK, SHALL BE DONE WITH APPLICABLE MATERIALS SO THAT SURFACES REPLACED WILL UPON COMPLETION MATCH SURROUNDING SIMILAR SURFACES.
- SURFACES REPLACED WILL UPON COMPLETION MATCH SURROUNDING SIMILAR SURFACES.

 1. SHOP DRAWINGS: SHOP DRAWINGS ARE AN AID FOR FIELD PLACEMENT AND ARE SUPERSEDED BY THE ARCHITECTURAL DRAWINGS. IT SHALL BE THE RESPONSIBILITY OF THE GENERAL CONTRACTOR TO MAKE CERTAIN THAT ALL CONSTRUCTION IS IN FULL AGREEMENT WITH THE LATEST ARCHITECTURAL DRAWINGS. THE CONTRACTOR SHALL SUPPLY THE ARCHITECTURAL BRAWINGS BEARING THE CONTRACTOR'S STAMP OF APPROVAL AND SIGNATURE A MINIMUM OF THREE WEEKS PRIOR TO FABRICATION. THE REVIEW OF SHOP DRAWINGS SHAND SPECIFICATIONS BY THE ARCHITECT PROINEER IS ONLY FOR GENERAL COMPLIANCE WITH THE ARCHITECTURAL AND/OR STRUCTURAL DRAWINGS AND SPECIFICATIONS. THIS REVIEW DOES NOT GUARANTEEN AND/OR STRUCTURAL DRAWINGS AND SPECIFICATIONS. THIS REVIEW DOES NOT GUARANTEEN AND/OR STRUCTURAL DRAWINGS. NO PORTION OF THE WORK REQUIRING A SHOP DRAWINGS ARE CORRECT, COMPLETE, NOR DOES IT INFER THAT THEY SUPERCEDE THE ARCHITECTURAL AND/OR STRUCTURAL AND/OR STRUCTURAL AND/OR STRUCTURAL DRAWINGS. NO PORTION OF THE SUBMISSION HAS BEEN REVIEWED BY THE ARCHITECTS LAU SUCH PORTIONS OF THE WORK THALL SUBMISSION SHALL COMMENCE UNTIL THE SUBMISSION OF STRUCTURAL DRAWINGS. THE ARCHITECT SHALL NOT PROCEED WITH THE REVIEW DE SHOP DRAWINGS AND SAMPLES STRUED. THE ARCHITECT SHALL NOT PROCEED WITH THE REVIEW OF SHOP DRAWINGS FOR A SPECIFICATION OF SPECIFICATIONS OF THE SHOP DRAWINGS FOR A SPECIFICATION OF SPECIFICATIONS OF THE SHOP DRAWINGS FOR A SPECIFIC SECTION OF SPECIFICATIONS OF THE SHOP DRAWINGS FOR A SPECIFIC SECTION OF SPECIFICATIONS OF THE SHOP DRAWINGS FOR A SPECIFIC SECTION OF SPECIFICATIONS OF THE SHOP DRAWINGS FOR A SPECIFIC SECTION OF SPECIFICATIONS OF THE SHOP DRAWINGS FOR A SPECIFIC SECTION OF SPECIFICATIONS OF THE SHOP DRAWINGS FOR A SPECIFIC SECTION OF SPECIFICATION OF SPECIFICATIONS OF THE SHOP DRAWINGS FOR A SPECIFIC SECTION OF SPECIFICATION.
- 12. DIMENSIONS:
 A. ALL DIMENSIONS SHALL BE VERIFIED IN THE FIELD.
 B. ALL DIMENSIONS SHOWN ARE TO THE CENTER OF COLUMNS AND BEAMS, FACE OF CONCRETE /
 CONC. BLOCK WALLS, EDGE OF SLAB, FACE OF FINISH UNLESS OTHERWISE NOTED.
 C. CEILING HEIGHT DIMENSIONS ARE FROM FINISHED FLOOD OR SLAB TO THE FINISHED FACE OF
- CEILINIS.

 D. DIMENSIONS AND ELEVATIONS ARE TO THE TOP OF CONCRETE, BLOCK OR OTHER HARD SURFACE MATERIALS, NOT TO THE TOP OF LODR COVERINGS OR ROOFING U.O.N.

 E. DO NOT SCALE DRAWINGS: FOLLOW IMMISSIONS
- 14 THE BUILDING INSPECTOR SHALL BE NOTIFIED PRIOR TO START OF CONSTRUCTION
- THE CONTRACTOR SHALL PROVIDE TEMPORARY EXIT SIGNS TO ASSURE A MEANS OF EGRESS DURING CONSTRUCTION.
- 16. AT LEAST ONE FIRE EXTINGUISHER WITH A MINIMUM RATING OF 2-A-10B:C SHALL BE PROVIDED WITHIN 75 FEET MAXIMUM TRAVEL DISTANCE FOR EACH 6.000 SF OR PORTION THEREOF ON EACH

PROJECT DIRECTORY

WILLIAM SELLER, ANDREI STAMATIOU, DANIEL STAMATIOU 4011 LOS ARABIS DR, LAFAYETTE, CA 94549

ARCHITECT

THE LANDREGAN TRACTON AND AND P.M. 7390 House In RM. 9048 Indicates

0 VALLEJO (Pormerly 10th or March) ST.

0410

@1720

DOYLE (Formerly #11) ST. Daves

BARAN STUDIO ARCHITECTURE MATTHEW BARAN 5621 LOWELL STREET OAKLAND, CA 94612 510-595-6744

For Assessment Use Only

LDA 8-50

BAY AREA LAND SURVEYING, INC. 3065 Richmond Parkway, Suite 101 Richmond, CA 94806

SURVEYOR

PARCEL MAP

(1470)

1469

510-223-5167

PROJECT INFO

06/07/2021

PROJECT SUMMARY

LOCATION: 1270 64TH STREET EMERYVILLE, CA 94608 LOT DIMENSIONS: 40' X 107' APPROX. LOT AREA: 3,553 SQ FT 049-1470-010-3 ZONING DISTRICT: RMH OCCUPANCY GROUP: R3

PLANNING SUBMITTAL

DEMOLITION OF EXISTING AND DAMAGED SINGLE-FAMILY STRUCTURES AND NEW CONSTRUCTION OF (2) NEW SINGLE-FAMILY HOUSES

CONSTRUCTION TYPE: PROPOSED # OF STORIES: 2 STORIES MAX BUILDING HEIGHT:

MAX FAR-PROPOSED F.A.R: 8.0

PROPOSED BUILDING HEIGHT:

MAX DENSITY: 2 UNITS PROPOSED DENSITY: 2 UNITS

PROPOSED FOOTPRINT: 1766.7 SO. FT LOT COVERAGE:

UNIT 1 GROSS AREAS 1,447 SQ. FT UNIT 1 GARAGE 255 SO. FT UNIT 2 GROSS AREAS 1514 SO. FT GROSS AREA TOTAL: 2,961 SQ. FT

NO. OF BEDROOMS UNIT 1: NO. OF BEDROOMS UNIT 2:

PROPOSED PARKING: 1 PARKING SPACE

SETBACKS FRONT SIDE (W) SIDE (E) REAR BLDG. SEP. UNIT #1 13' - 6" 15' - 0' 15' - 0" UNIT #2 15' - 0" 15' - 0" 12' - 0"

DRAWING SHEET INDEX

ARCHITECTURE

PROJECT INFORMATION AND SHEET INDEX

SITE CONTEXT

A100 SITE PLAN FLOOR PLANS

ELEVATION - SOUTH A201 ELEVATION - EAST

A301 RENDERED IMAGES

ABBREVIATIONS AND SYMBOLS SURVEY PLAN

EXISTING SITE PHOTOS

A102 ROOF PLAN LANDSCAPE PLAN

ELEVATION - NORTH ELEVATION - WEST

MATERIAL BOARD

BARAN STUDIO ARCHITECTURE

DAKLAND LOS ANGELES 510 595 674

CA

EMERYVILL

ST

64TH

1270

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APPLICABLE CODES & AGENCIES

THE INTENT OF THE DRAWINGS AND SPECIFICATIONS IS TO CONSTRUCT REFERENCED PROJECT IN COVERED BY THE CONTRACT DOCUMENTS WHEREIN THE FINISHED WORK WILL NOT COMPLY WIT SAID CALIFORNIA CODE OF REGULATIONS TITLE 24, A CHANGE ORDER DETAILING AND SPECIFYING THE REQUIRED WORK SHALL BE SUBMITTED TO AND APPROVED BY THE AGENCY HAVING JURISDICTION BEFORE PROCEEDING WITH THE WORK.

CALIFORNIA CODE OF REGULATIONS (CCR)

2019 CALIFORNIA BUILDING CODE - PART 2, TITLE 24, CCR (BASED UPON 2019 CRC CALIFORNIA RESIDENTIAL CODE)

2019 CALIFORNIA ELECTRICAL CODE - PART 3, TITLE 24, CCR (BASED UPON 2017 NATIONAL ELECTRICAL CODE)

2019 CALIFORNIA MECHANICAL CODE - PART 4, TITLE 24, CCR (BASED UPON 2018 UNIFORM MECHANICAL CODE)

2019 CALIFORNIA PLUMBING CODE - PART 5. TITLE 24. CCR

(BASED UPON 2018 UNIFORM PLUMBING CODE 2019 CALIFORNIA ENERGY CODE - PART 6, TITLE 24, CCR

2019 CALIFORNIA GREEN BUILDING STANDARDS CODE

LOCATION MAP



1276

SITE IMAGES






PROJECT INFO AND SHEET INDEX

DATE: 06/07/2021 SCALE: 3" = 1'-0"

ABBREVIATIONS SYMBOLS AIR CONDITIONING ABOVE ASPHALT CONCRETE FIRE ALARM FIRE ALARM CONTROL PANEL FLAT BAR NEW NORTH NOT IN CONTRACT A/C ABV AC ACCS ACOUS **GRID SYMBOL** TONGUE AND GROOVE ADA ACCESSIBLE FLOOR CLOSER GRID DESIGNATION -ACOUSTICAL FLOOR DRAIN / FIRE DAMPER NOMINAL TOP OF CURB GRID LINE -ACP ACT AD ADDL NON-RATED NOT TO SCALE AREA DRAIN FIRE EXTINGUISHER TERRAZZO **ROOM IDENTIFIER** ADDITIONAL FIRE EXTINGUISHER CABINET THERMAI ADJITIONAL ADJUSTABLE ABOVE FINISH FLOOR AGGREGATE ADJ AFF AGGR FLAT HEAD FIRE HOSE CABINET OVERHEAD TOP OF CONCRETE OVERALL ON CENTER TOP OF PAVING ALUMINUM FLOOR OUTSIDE DIAMETER / DIMENSION AI TERNATE FLUORESCENT OWNER FURNISHED CONTRACTOR INSTALLED BARAN STUDIO ARCHITECTURE ANCHOR ANODIZED DAKLAND LOS ANGELES 510 595 674 OWNER FURNISHED OWNER INSTALLED APPROX APPROXIMATE FACE OF EQUIPMENT TRANSFORMER ARCH ASPH AUTO ARCHITECT / ARCHITECTURAL FACE OF FINISH OPPOSITE HAND TREAD **CEILING HEIGHT** FACE OF FINISH FACE OF GLASS FACE OF STUD FIREPROOF /ING TELEVISION CEILING HEIGHT — **→** (12'-0") BOARD UNDERWRITERS LABORATORIES FROM / FIRE RATED BACKING FIRE SPRINKLER / FULL SIZE PENN PENETRATION UNLESS OTHERWISE NOTED BLDG BLKG BM BOT BR BRKT BSMT BUILDING BLOCKING BEAM FOOT / FFFT PERFORATED FOOTING FIRE TREATED DRAWING DETAIL BOTTOM PLUMBING VEST VIF VESTIBULE BACKER ROD FUTURE PLYWOOD VERIFY IN FIFI D DETAIL NUMBER -BRACKET BASEMENT BETWEEN PNL POL PR PRCST VENT TROUGH ROOF 4 A-901 GAUGE GALVANIZED SHEET LOCATION -CAWEST / WIDTH BTWN BUR PRECAST BUILT-UP ROOF GRAB BAR EMERYVILLE, GENERAL CONTRACTOR PREFABRICATED WITHOUT S CAB CB CEM CER CFCI CFOI CG CH CI CIP CJ CL **EXTERIOR ELEVATION** GROUND POUNDS PER SQUARE INCH WINDOW **64TH** CERAMIC GRADE POINT / PAINT WIRE GLASS SHEET NUMBER -CONTRACTOR FURNISHED CONTRACTOR INSTALLED GYPSUM WALL BOARD PAINTED DRAWING NUMBER WATER METER WHERE OCCURS HOSE BIB PTRWD PVC PRESSURE TREATED WOOD WATERPROOF / ING CAST IRON HOLLOW CORE POLYVINYL CHLORIDE WORKING POINT CAST IRON CAST IN PLACE CONTROL JOINT CENTERLINE HARDBOARD HEADER HARDWOOD WATER RESISTANT WALL / BLDG SECTION ST CLG CLO CLR CMU COL COMM 64TH DETAIL NUMBER CEILING HDWR HM HARDWARE WELDED WIRE MESH CLOSET HOLLOW METAL REVEAL / RISER SHEET NUMBER CLEAR CONCRETE MASONRY UNIT RADIUS RESILIENT BASE REFLECTED CEILING PLAN COLUMN ARROW INDICATES DIRECTION OF COMMUNICATION/S HOLLOW STRUCTURAL SECTION ROOF DRAIN COMPENSATING/ION REDWOOD CONST CONSTRUCTION REFRIGERATOR **DETAIL REFERENCE** INSIDE DIAMETER / DIMENSION CONTINUOUS REINFORCEMENT / ING / FD CONTR COORD CORR CONTINUOUS CONTRACTOR COORDINATE CORRIDOR REQUIRED RESILIENT RETAINING / RETARDANT INCANDESCENT INCLUDE / ING **DETAIL SECTION** CPT CR CT CTR CTSK CW CARPET INSUL INT INSULATION / ING REVISION CARD READER INTERIOR REGISTER ROOM ROUGH OPENING RAIN WATER LEADER INTER INV COUNTERSUNK INTERIOR ELEVATION JANITOR / IAL CURTAIN WALL SOUTH / SINK DB DBL DD DEMO SELF-ADHERING FLASHING SANITARY SELF-ADHERING SHEET MEMBRANE DUST BARRIER DOUBLE DESCRIPTION DATE DETAIL NUMBER -A500 SHEET NUMBER -DECK DRAIN DEMOLISH / DEMOLITION KTCHN SOLID CORE SEE CIVIL DRAWINGS DEPARTMENT DET / DTL DF HEIGHT/ELEVATION DATUM DIAMETER LAMINATE /D STORM DRAIN / SOAP DISPENSER DIAGONAL LAVATORY POUND LOCKER LONG LEGS BACK TO BACK SEE ELECTRICAL DRWAINGS SQUARE FOOT / FEET DN DO DR DSA DWG /S DWR SHOWER DOOR OPENING LONG LEG HORIZONTAL LONG LEG VERTICAL DIVISION OF STATE ARCHITECT DRAWING/S DOOR SYMBOL SEISMIC JOINT DRAWER LIGHT LIMITED SHORT LEGS BACK TO BACK EXISTING LIGHT WEIGHT SEE LANDSCAPE DRAWINGS SHEET METAL SEE MECHANICAL DRAWINGS MACH MAT MACHINE EACH SIDE FACH WAY MATERIAL SANITARY NAPKIN DISPENSE EXPANSION BOLT EACH FACE EMERGENCY GENERATOR **ABBREVIATIONS &** MAYIMIIM SANITARY NAPKIN RECEPTACLE PARTITION TYPE SYMBOL SOFFIT SLAB ON GRADE SYMBOLS MEDIUM DENSITY FIBERBOARD PARTITION TYPE DESIGNATION : EXPANSION JOINT MECHANICAL > ? SEE PLUMBING DRAWINGS FIEVATION MEDIUM / MEDICINE ELECTRICAL ELEVATOR ELECTRICAL METER MEMBRANE MEZZANINE MANUFACTURER SPECIFICATION /S SQUARE STAINLESS STEEL / SANITARY SEWER WINDOW TYPE SYMBOL EMBED /MENT MANHOLE SANITARY SEWER CLEANOUT MINIMUM / MINUTE EMERGENCY SEE STRUCTURAL DRAWINGS WINDOW TYPE DESIGNATION SEE WINDOW SCHEDULE ENCLOSURE ENGINEER ENCL ENGR EOS EP EQ EQUIP ETC EXP EXT EXT EDGE OF SLAB MOUNTED STANDARD PROJECT NO.: UPDR20-004 ELECTRICAL PANEL MOUNTING EQUAL EQUIPMENT ETCETERA DATE: 06/07/2021 **REVISION SYMBOL** STRUCTURAL SUSPENDED SCALE: 12" = 1'-0" REVISION NUMBER EXPANSION / EXPOSED SOUARE YARD SHEET NO: FXTFRIOR SYMMETRICAL CLOUD INDICATES AREA OF REVISION A002

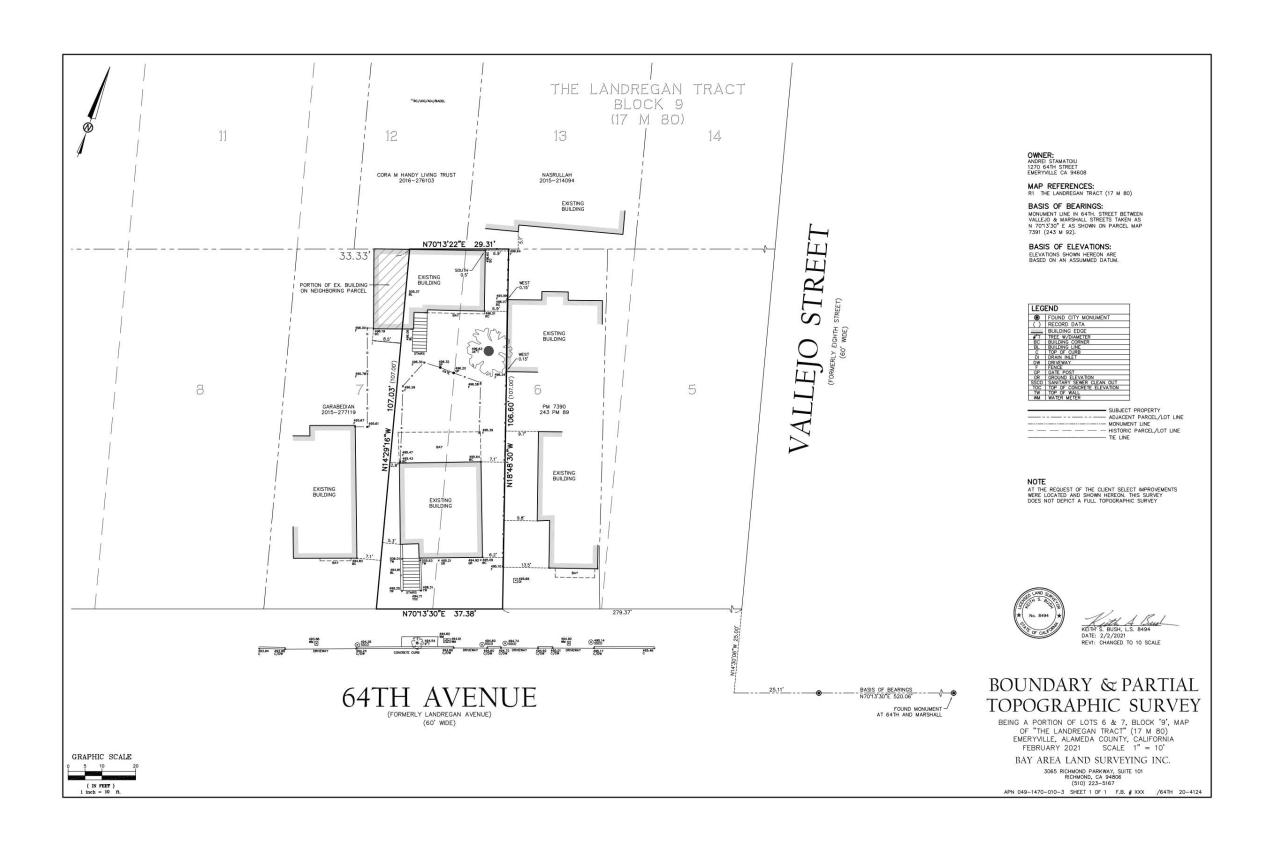



1270 64TH ST

1270 64TH ST EMERYVILLE, CA

NO. DESCRIPTION DATE
1 PLN R1 03/30/202

STAMP:



SURVEY PLAN

PROJECT NO.: UPDR20-004 DATE: 06/07/2021 SCALE:

SHEET NO:









OAKLAND | LOS ANGELES 510 595 674

8 64TH ST. & DOYLE ST. - NORTHEAST CORNER

6 64TH ST. NORTHEAST VIEW



2 64TH ST. - INFRONT OF THE PROPERTY




1270 64TH ST

1270 64TH ST EMERYVILLE, CA

4 64TH ST. - NORTHWEST VIEW



1 1270 64TH STREET

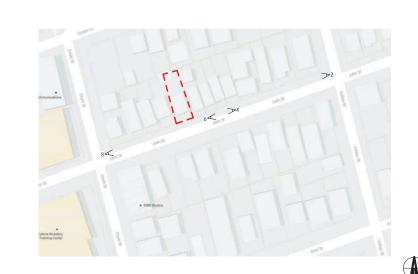

STAMP:



SITE CONTEXT

PROJECT NO.: UPDR20-004 DATE: 06/07/2021 SCALE:

SHEET N


A004



3 64TH ST. SOUTHWEST VIEW

GOOGLE MAP FOR VIEWS REFERENCE



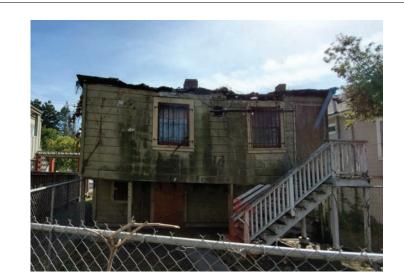

1270 64TH ST EMERYVILLE, CA

1270 64TH ST



EXISTING SITE PHOTOS

PROJECT NO.: UPDR20-004 DATE: 06/07/2021 SCALE:

SHEET NO:

A005

3 FRONT UNIT - REAR SIDE 5 REAR UNIT - FRONT VIEW





4 REAR UNIT - FRONT VIEW





2 FRONT UNIT - EAST SETBACK



3 FRONT UNIT - WEST SETBACK LOOKING TOWARDS 64TH STREET

1 FRONT UNIT - WEST SETBACK

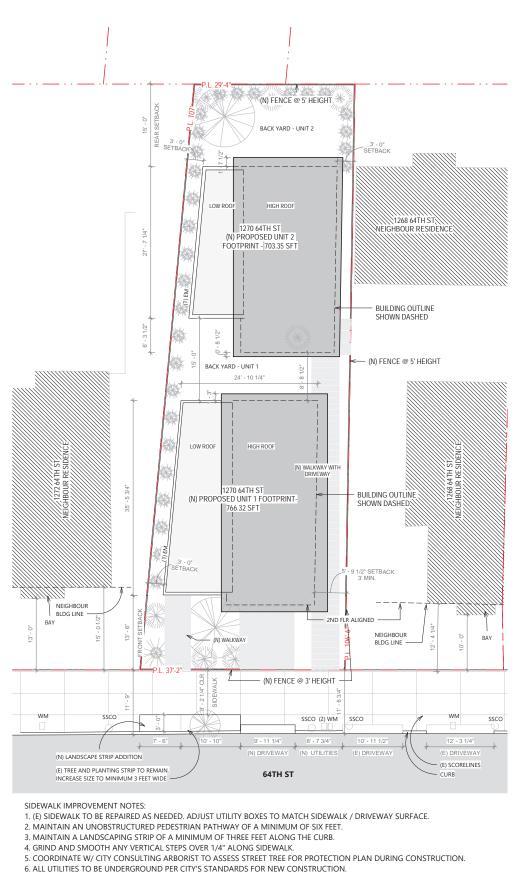

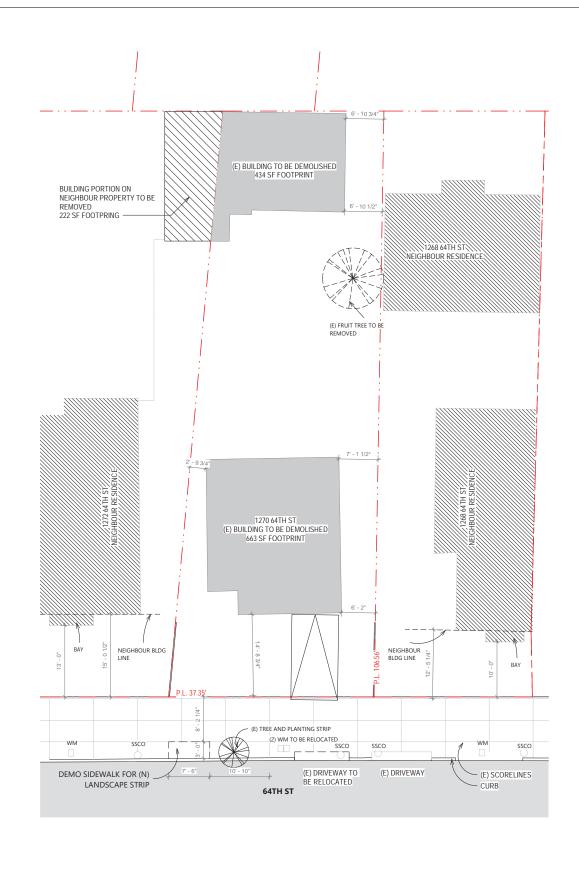

1270 64TH

1270 64TH ST EMERYVILLE, CA

DATE

BARAN STUDIO ARCHITECTURE

OAKLAND LOS ANGELES 510 595 6744

DESCRIPTION



SITE PLAN

PROJECT NO.: UPDR20-004 DATE: 06/07/2021 SCALE: 1/8" = 1'-0"

SHEET NO:

Graphic Scale: 1 inch = 8 feet

A100

SITE PLAN_EXISTING


1/8" = 1'-0"

SITE PLAN_PROPOSED



2 LEVEL 2

1/8" = 1'-0"

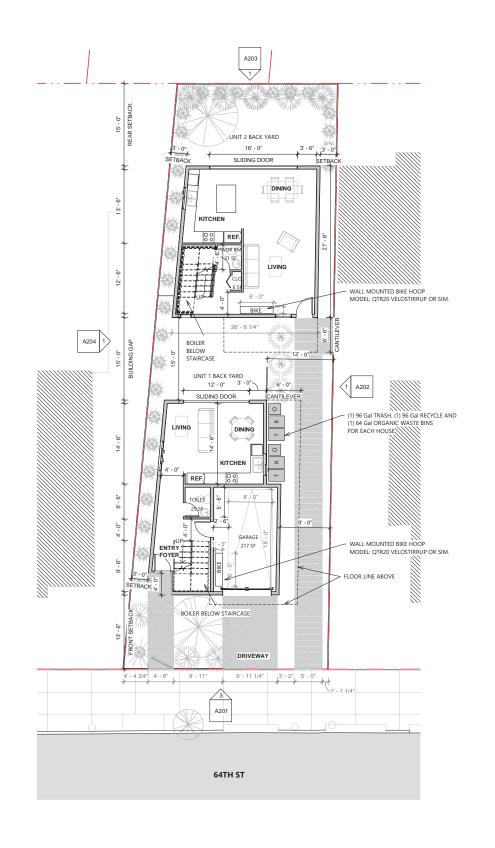

NOTES:

FRONT UNIT GROSS AREA GARAGE - 255 SF LEVEL 1 - 491 SF LEVEL 1 LEVEL 2 956 SF TOTAL - 1,447 SF

REAR UNIT GROSS AREA LEVEL 1 - 703.35 SF LEVEL 2 - 810.3 SF TOTAL - 1,514 SF

WALL / LINE LEGEND





BARAN STUDIO ARCHITECTURE
OAKLAND | LOS ANGELES 510 595 6744

1270 64TH

1270 64TH ST EMERYVILLE, CA

NO.	DESCRIPTION	DA
1	PLN R1	03/30
2	PLN R2	05/07
		_
STA	MP:	



FLOOR PLANS


PROJECT NO.: UPDR20-004 DATE: 06/07/2021 SCALE: As indicated

SHEET NO:

Graphic Scale: 1 inch = 8 feet

A101

1 LEVEL 1

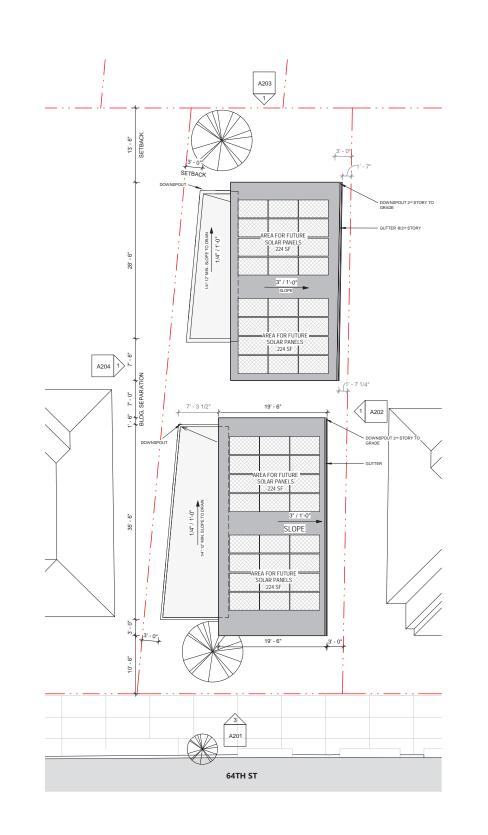



1270 64TH ST

1270 64TH ST EMERYVILLE, CA

NO. DESCRIPTION




ROOF PLAN

PROJECT NO.: UPDR20-004 DATE: 06/07/2021 SCALE: 1/8" = 1'-0"

A102

1 -ROOF_ SCALE: 1/8" = 1'-0"

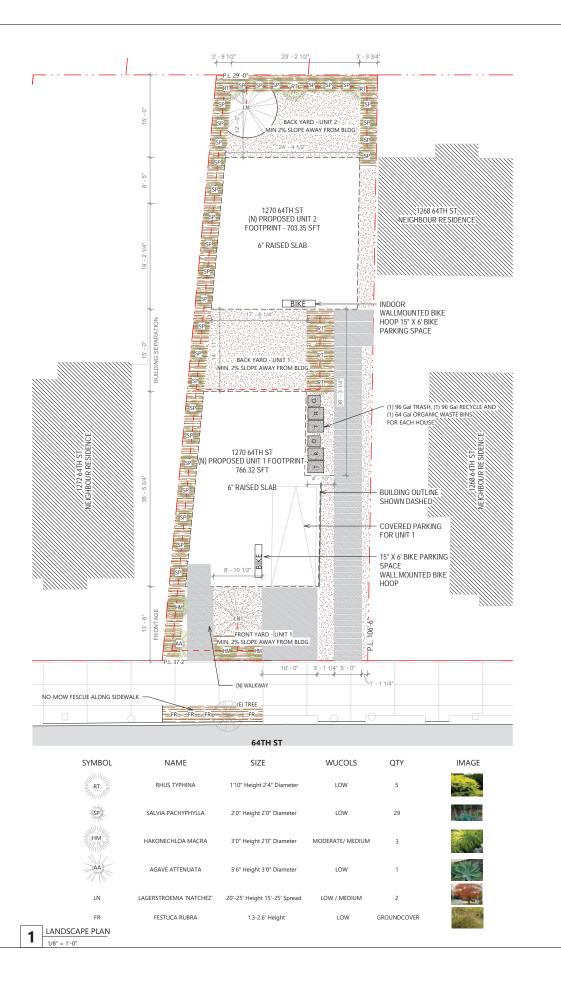

IRRIGATION

- AUTOMATIC IRRIGATION CONTROLLERS
 ARE REQUIRED AND MUST USE
 EVAPOTRANSPIRATION OR SOIL MOISTURE
 SENSOR DATA AND UTILIZE A RAIN SENSOR.
- 2. IRRIGATION CONTROLLERS SHALL BE OF A TYPE WHICH DOES NOT LOSE PROGRAMMING DATA IN THE EVENT THE PRIMARY POWER SOURCE IS INTERRUPTED.
- 3. PRESSURE REGULATORS SHALL BE INSTALLED ON THE IRRIGATION SYSTEM TO ENSURE THE DYNAMIC PRESSURE OF THE SYSTEM IS WITHIN THE MANUFACTURER'S RECOMMENDED PRESSURE RANGE.
- 4. MANUAL SHUT-OFF VALVES (SUCH AS A GATE VALVE, BALL VALVE, OR BUTTERFLY VALVE) SHALL BE INSTALLED AS CLOSE AS POSSIBLE TO THE POINT OF CONNECTION TO THE WATER SUPPLY.
- 5. ALL IRRIGATION EMISSION DEVICES MUST MEET THE REQUIREMENTS SET IN THE ANSI STANDARD, ASABE/ICC 802-2014.
- 6. AREAS LESS THAN 10 FEET IN WIDTH IN ANY DIRECTION SHALL BE IRRIGATED WITH SUBSURFACE IRRIGATION OR OTHER MEANS THAT PRODUCES NO IRRIGATION RUNOFF OR OVERSPRAY.

LEGEND

STURE ENSOR.

CONCRETE PAD / PAVERS, PERVIOUS MULCH, PERVIOUS

MULCH, PERVIOUS - 608 SF
DECOMPOSED GRANITE - 804 SF

- 805 SF

__ _ _ D

DRIP IRRIGATION LINE

NOTE:

Total landscaped area - 608 sft

SITE DEVELOPMENT REGULATIONS

9-4.303 OPEN SPACE

(5) USES EXEMPTED FROM (a) OPEN SPACE REQUIREMENTS = TWO (2) UNIT RESIDENTIAL USE TYPES.

9-4.504 LANDSCAPE REQUIREMENTS BY ZONING DISTRICT

10% MIN OF PROJECT SITE
SITE =3,554 SQF
LANDSCAPE REQUIRED = 355 SQF
LANDSCAPE PROVIDED = 608 SQF

"LANDSCAPING" DEFINITION: LIVING VEGETATION, PLANTED IN THE GROUND, INCLUDING SOME COMBINATION OF TREES, GROUND COVER, SHRUBS, VINES, FLOWERS, OR LAWNS. IN ADDITION, THE COMBINATION OR DESIGN MAY INCLUDE NATURAL FEATURES SUCH AS ROCK AND STONE; AND STRUCTURAL FEATURES, SUCH AS FOUNTAINS, REFLECTING POOLS, ARTWORKS, SCREEN WALLS, FENCES AND BENCHES.

EMERYVILLE PRESCRIPTIVE REQUIREMENTS

AMENDMENTS AND MULCH

- 1. AT LEAST 6 CUBIC YARDS OF COMPOST, WITH A COMPOSITION ACCORDING TO CITY STANDARDS OR A CITY-APPROVED SOIL REPORT RECOMMENDATION, PER 1,000 SQUARE FEET SHALL BE INCORPORATED INTO THE TOP 6 INCHES OF SOIL.
- 2. A MINIMUM 3-INCH LAYER OF MULCH SHALL BE APPLIED ON ALL EXPOSED SOIL SURFACES OF PLANTING AREAS EXCEPT IN TURF AREAS, AREAS RECEIVING CLOSELY SPACED PLUGS AS A LAWN ALTERNATIVE, AREAS WITH CREEPING OR ROOTING GROUND COVERS, OR DIRECT SEEEDING APPLICATIONS WHERE MULCH IS CONTRAINDICATED. NONPOROUS MATERIALL SHALL NOT BE PLACED UNDER THE MULCH.
- 3. REQUIRED TREES SHALL HAVE ADEQUATE ROOTABLE SOIL VOLUME (600 CUBIC FEET FOR SMALL TREES, 900 FOR MEDIUM-SIZE, AND 1,200 CUBIC FEET FOR LARGE TREES).



BARAN STUDIO ARCHITECTURE
OAKLAND LOS ANGELES 510 595 6744

CA

ST EMERYVILLE,

64TH !

1270

270 64TH ST

NO.	DESCRIPTION	DATI
	PLN R1	03/30/20
:	PLN R2	05/07/20
STAI	MP:	



LANDSCAPE PLAN



PROJECT NO.: UPDR20-004 DATE: 06/07/2021 SCALE: 1/8" = 1'-0"

SHEET NO:



NOTE: ELEVATION CUT LINE IS FLUSHED TO FRONT PROPERTY LINE. REFER TO FLOORPLAN FOR ACCURATE HORIZONTAL BUILDING MEASUREMENTS RELATIVE TO SIDE PROPERTY LINES.





BARAN STUDIO ARCHITECTURE
OAKLAND | LOS ANGELES 510 595 6744

1270 64TH ST EMERYVILLE, CA

1270 64TH

NO.	DESCRIPTION	DAT
1	PLN R1	03/30/2
2	PLN R2	05/07/2



ELEVATION - SOUTH

PROJECT NO.: UPDR20-004 DATE: 06/07/2021 SCALE: 1/4" = 1'-0"

SHEET NO:





NOTE: ELEVATION CUT LINE IS FLUSHED TO REAR PROPERTY LINE. REFER TO FLOORPLAN FOR ACCURATE HORIZONTAL BUILDING MEASUREMENTS RELATIVE TO SIDE PROPERTY LINES.





BARAN STUDIO ARCHITECTURE
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1270 64TH ST EMERYVILLE, CA

1270 64TH ST

NO.	DESCRIPTION	DATE
2	PLN R2	05/07/202



ELEVATION - NORTH

PROJECT NO.: UPDR20-004 DATE: 06/07/2021 SCALE: 1/4" = 1'-0"

SHEET NO:





SOUTH EAST VIEW



SOUTH WEST VIEW



SOUTH (FRONT) VIEW



REAR UNIT VIEW



BARAN STUDIO ARCHITECTURE OAKLAND | LOS ANGELES 510 595 6744

1270 64TH ST

1270 64TH ST EMERYVILLE, CA

NO.	DESCRIPTION	DATE
2	PLN R2	05/07/2021


STAMP:



RENDERED IMAGES

PROJECT NO.: UPDR20-004 DATE: 06/07/2021 SCALE:

SHEET NO:

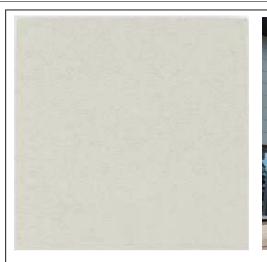





1. BUILDING VOLUME: NICHIHA SAVANNAH SMOOTH WOOD LAP SIDING COLOR: PRIMED, OFF-WHITE DIMENSION: 8-1/4" X 9' 4"
THICKNESS: 1/2"

RESCPH120612 6" Siding (WxHxL)1/2"x6"x12"



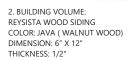




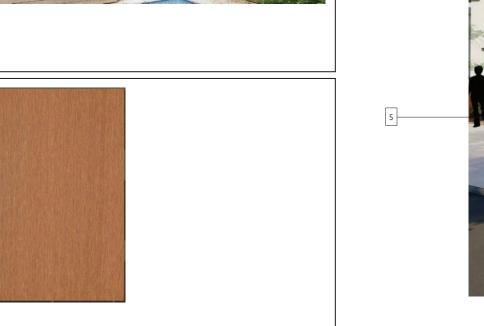





3. FASCIA & RAINWATER PIPE/ GUTTER COLOR: BLACK

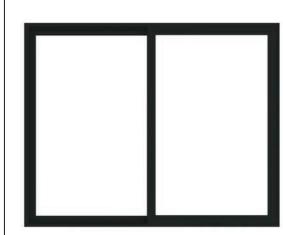

Exterior



4. ANDERSON WINDOWS MODEL: 100 SERIES



5. REDWOOD FENCE/ GATE



BARAN STUDIO ARCHITECTURE
OAKLAND | LOS ANGELES 510 595 6744

1270 64TH

1270 64TH ST EMERYVILLE, CA

NO.	DESCRIPTION	DATE
1	PLN R1	03/30/202
2	PLN R2	05/07/202





MATERIAL BOARD

PROJECT NO.: UPDR20-004 DATE: 06/07/2021 SCALE: