&	AND	HOR.	HORIZONTAL
@	AT	HT.	HEIGHT
C	CENTERLINE	HM.	HOLLOW METAL
ACOUS.	ACOUSITCAL	I.D.	INSIDE DIAMETER
ADJ.	ADJACENT	I.G.	INSULATED GLASS
A.F.F.	ABOVE FINISH FLOOR	INSUL.	INSULATION
A.F.G.	ABOVE FINISH GRADE	INT.	INTERIOR
AL.	ALUMINUM	LAM.	LAMINATE
APPROX.	APPROXIMATE	LAV.	LAVATORY
ARCH.	ARCHITECTURAL	LT.	LIGHT
BD.	BOARD	K.E.C.	KITCHEN EQUIPMENT CONTRACTOR
BLDG.	BUILDING	MAX.	MAXIMUM
BK.	BLOCK	M.C.	MECHANICAL CONTRACTOR
BLKG.	BLOCKING	MECH.	MECHANICAL
BM.	BEAM	M.E.P.	MECHANICAL ELECTRICAL PLUMBING
B.O.	BOTTOM OF	MFR.	MANUFACTURER
C.B.	CATCH BASIN	MGR.	MANAGER
CEM.	CEMENT	MIN.	MINIMUM
CER.	CERAMIC	MISC.	MISCELLANEOUS
CL.	CLOSET	MTD.	MOUNTED
CLR.	CLEAR	MTL.	METAL
CLG.	CEILING	N.I.C. N.I.K.E.C.	NOT IN CONTRACT
COL.	COLUMN	N.I.K.E.C.	NOT IN KITCHEN EQUIP. CONTRACT
CONC.	CONCRETE	N.T.S.	NOT TO SCALE
CONN.	CONNECTION	O.C.	ON CENTER
CONST.	CONSTRUCTION	O.D.	OUTSIDE DIAMETER
CONT.	CONTINUOUS	OPP.	OPPOSITE
CONTR.	CONTRACTOR	P.C.	PLUMBING CONTRACTOR
CNTR.	COUNTER	PL.	PLATE
CTR.	CENTER	PLAM	PLASTIC LAMINATE
D.F.	DOUGLAS FIR	PLAS.	PLASTER
DBL.	DOUBLE	PLYWD.	PLYWOOD
DEPT.	DEPARTMENT	PR.	PAIR
DET.	DETAIL	P.T.	PRESSURE TREATED
DIA.	DIAMETER	PTD.	PAINTED
DIM.	DIMENSION	R.	RADIUS
DISP.	DISPENSER	R.D.	ROOF DRAIN
DN.	DOWN	REF.	REFRIGERATOR
D.S.	DOWN SPOUT	RM.	ROOM
DWG.	DRAWING	RWD.	REDWOOD
(E)	EXISTING	R.W.L.	RAINWATER LEADER
EA.	EACH	S.A.	SMOKE ALARM
E.C.	ELECTRICAL CONTRACTOR	S.C.	SOLID CORE
EL.	ELEVATION	SCHED.	SCHEDULE
ELEC.	ELECTRICAL	SECT.	SECTION
ELEV.	ELEVATOR	SHT.	SHEET
EMER.	EMERGENCY	SIM.	SIMILAR
ENCL.	ENCLOSURE	SPEC.	SPECIFICATION
EQ.	EQUAL	SQ.	SQUARE
EQP.	EQUIPMENT	S&R	SHELF AND ROD
EXT.	EXTERIOR	S.S.	STAINLESS STEEL
F.A.	FIRE ALARM	STD.	STANDARD
F.D.	FLOOR DRAIN	STL.	STEEL
F.F.	FINISH FACE	STR.	STRUCTURE
F.R.P.	FIBER REINFORCED PANEL	SUSP.	SUSPENDED
F.T.	FIRE TREATED	T.V.	TELEVISION
FDN.	FOUNDATION	T.O.	TOP OF
FIN. FL.	FINISH FLOOR	TRAN.	TRANSOM
FLUOR.	FLUORESCENT	TYP.	TYPICAL
FPRF.	FIRE PROOF	U.O.N.	UNLESS OTHERWISE NOTED
FT.	FOOT/ FEET	V.I.F.	VERIFY IN FIELD
FTG.	FOOTING	VERT.	VERTICAL
GA.	GAUGE	W/	WITH
GALV.	GALVANIZED	W.C.	WATER CLOSET
G.B.	GRAB BAR	WD.	WOOD
G.C.	GENERAL CONTRACTOR	W/O	WITHOUT
GL.	GLASS	W.R.	WATER RESISTANT
GND.	GROUND	WT.	WEIGHT
GYP.	GYPSUM	WWM	WELDED WIRE MESH
ADDDE	VIATIONS		
MODE	VIATIONS		
	DOOD MUMDED		DEFEDENCE TO LIGHT
(1)	DOOR NUMBER	~ <u>A</u> }	REFERENCE TO LIGHT

WINDOW NUMBER

REFERENCE TO

DETAIL REFERENCE

FLEVATION

- REFERENCE

NOTATION

DISCONTINUITY

SYMBOLS

- SHEET NUMBER

FIXTURE

REFERENCE TO

DATUM POINT

- REFERENCE

REVISION

ALIGN FINISH SURFACES

FIXTURE / FURNITURE

1. SCOPE DOCUMENTS: THESE DRAWINGS INDICATE THE GENERAL SCOPE OF THE PROJECT IN TERMS OF THE OVERALL CONCEPT, THE DIMENSIONS OF THE BUILDING, THE MAJOR ARCHITECTURAL ELEMENTS AND THE TYPE OF STRUCTURAL, MECHANICAL, ELECTRICAL SYSTEMS, ON THE BASIS OF THE GENERAL SCOPE INDICATED OR DESCRIBED. THE CONTRACTOR SHALL FURNISH ALL ITEMS REQUIRED FOR THE PROPER EXECUTION AND COMPLETION OF THE WORK. APPROVAL BY THE CITY INSPECTOR DOES NOT CONSTITUTE AUTHORITY TO DEVIATE FROM THE PLANS

2. THE FOLLOWING NOTES AND TYPICAL DETAILS APPLY TO ALL DRAWINGS LINLESS

3.DRAWINGS INDICATE GENERAL AND TYPICAL DETAILS OF CONSTRUCTION. WHERE CONDITIONS ARE NOT SPECIFICALLY INDICATED BUT ARE OF SIMILAR CHARACTER TO DETAILS SHOWN, DETAILS OF CONSTRUCTION SHALL BE USED SUBJECT TO THE REVIEW AND APPROVAL OF THE ARCHITECT.

4. THE CONTRACTOR SHALL PERFORM IN A MANNER CONFORMING TO APPLICABLE REGULATIONS, AND REQUIREMENTS OF ALL GOVERNING AGENCIES AS WELL AS STANDARD INDUSTRY PRACTICES.

5. RESPONSIBILITY: THE CONTRACTOR SHALL VERIFY ALL DIMENSIONS AND SITE CONDITIONS BEFORE STARTING WORK. SHOULD A DISCREPANCY APPEAR IN THE SPECIFICATIONS OR DRAWINGS, OR IN THE WORK DONE BY OTHERS FROM THE CONTRACT DOCUMENTS THAT AFFECT ANY WORK, NOTIFY THE ARCHITECT AND OWNER IN WRITING AT ONCE FOR INSTRUCTIONS TO PROCEED. IF THE CONTRACTOR PROCEEDS WITH THE WORK AFFECTED WITHOUT WRITTEN INSTRUCTIONS FROM THE ARCHITECT, THE CONTRACTOR SHALL MAKE GOOD ANY RESULTING DAMAGE OR DEFECT TO THE SATISFACTION OF THE OWNER WITH NO RESULTING COST TO THE OWNER. SHOULD A CONFLICT OCCUR IN OR BETWEEN THE DRAWINGS AND SPECIFICATIONS, OR WHERE DETAIL REFERENCES ON THE CONTRACT DRAWINGS HAVE BEEN OMMITTED, THE CONTRACTOR IS DEEMED TO HAVE ESTIMATED THE MOST EXPENSIVE MATERIAL AND CONSTRUCTION METHODS INVOLVED, UNLESS A WRITTEN DECISION FROM THE ARCHITECT / OWNER HAS BEEN OBTAINED WHICH DESCRIBES AN ALTERNATE METHOD AND/OR MATERIALS OR UNLESS THE ORIGINAL

6. THE CONTRACTOR SHALL CONFINE HIS/HER OPERATIONS ON THE SITE TO AREAS PERMITTED BY THE OWNER. THE JOB SITE SHALL BE MAINTAINED IN A CLEAN, ORDERLY CONDITION FREE OF DEBRIS AND LITTER, AND SHALL NOT BE UNIREASONABLY ENCUMBERED WITH ANY MATERIALS OR EQUIPMENT. EACH SUBCONTRACTOR IMMEDIATELY UPON COMPLETION OF EACH PHASE OF HIS/HER WORK SHALL REMOVE ALL TRASH AND DEBRIS AS A RESULT OF HIS/HER OPERATION.

7. ALL MATERIALS STORED ON THE SITE SHALL BE PROPERLY STACKED AND PROTECTED TO PREVENT DAMAGE AND DETERIORATION UNTIL USE. FAILURE TO PROTECT MATERIALS MAY BE CAUSE FOR REJECTION OF WORK.

8. PROVIDE ALL NECESSARY BLOCKING, BACKING AND FRAMING FOR LIGHT FIXTURES, ELECTRICAL UNITS, PANELS HVAC EQUIPMENT AND ALL OTHER ITEMS REQUIRING SAME.

9. ALL MATERIALS SHALL BE HANDLED AND INSTALLED PER THE MANUFACTURER'S

10. STORAGE & DISPENSING OR USE OF ANY FLAMMABLE OR COMBUSTIBLE LIQUIDS, FLAMMABLE GASES AND HAZARDOUS CHEMICALS SHALL COMPLY WITH THE UNIFORM FIRE CODE REGULATIONS.

11. NO MATERIALS SHALL BE STORED ON PUBLIC PROPERTY UNLESS AN ENCROACHMENT PERMIT IS FIRST OBTAINED FROM THE PUBLIC WORK DEPARTMENT.

12. THE CONTRACTOR SHALL DO ALL CUTTING, FITTING, OR PATCHING OF HIS/HER 12. THE CONTRACTOR SHALL DO ALL CUTTING, HITTING, OF PATCHING OF HIS/HER WORK THAT MAY BE REQUIRED TO MAKE ITS SEVERAL PARTS HIT TOGETHER PROPERLY AND SHALL NOT ENDANGER ANY OTHER WORK BY CUTTING, ECXAVATING, OO THERWISS, ATTERING THE TOTAL WORK OR ANY PART OF IT. ALL PATCHING, REPAIRING, AND REPLACING OF MATERIALS AND SURFACES, CUT OR DAMAGED IN EXECUTION OF WORK, SHALL BE DONE WITH APPLICABLE MATERIALS. SO THAT SURFACES REPLACED WILL UPON COMPLETION MATCH SURROUNDING 13. SHOP DRAWINGS: SHOP DRAWINGS ARE AN AID FOR FIFLD PLACEMENT AND

INSIONS:

A. ALL DIMENSIONS SHALL BE VERIFIED IN THE FIELD.

B. ALL DIMENSIONS SHOWN ARE TO THE CENTER OF COLUMNS AND BEAMS, FACE OF CONCRETE / CONC. BLOCK WALLS, EDGE OF SLAB, FACE OF

C. CEILING HEIGHT DIMENSIONS ARE FROM FINISHED FLOOR OR SLAB TO THE FINISHED FACE OF CEILING. D. DIMENSIONS AND ELEVATIONS ARE TO THE TOP OF CONCRETE.

BLOCK OR OTHER HARD SURFACE MATERIALS, NOT TO THE TOP OF FLOOR COVERINGS OR ROOFING U.O.N. E. DO NOT SCALE DRAWINGS: FOLLOW DIMENSIONS

15. THE CONTRACTOR SHALL BE RESPONSIBLE FOR COORDINATING THE WORK OF

16. THE BUILDING INSPECTOR SHALL BE NOTIFIED PRIOR TO START OF

17. THE CONTRACTOR SHALL PROVIDE TEMPORARY EXIT SIGNS TO ASSURE A MEANS OF EGRESS DURING CONSTRUCTION.

18. AT LEAST ONE FIRE EXTINGUISHER WITH A MINIMUM RATING OF 2-A-10B-C SHALL BE PROVIDED WITHIN 75 FEET MAXIMUM TRAVEL DISTANCE FOR EACH 6.000 SF OR PORTION THEREOF ON EACH FLOOR.

PLANNING SUBMITTAL

19TH SEPTEMBER 2017

LOCATION: 5876 & 5880 Dovle Street. Emerwille CA 94608 OT DIMENSIONS: LOT AREA: 10,000 SF 49-1330-12 & 13

ZONING DISTRICT: MIXED USE WITH RESIDENTIAL (MUR)

CONSTRUCTION TYPE 3 STORIES # OF STORIES: EXISTING BUILDING HEIGHT: BUILDING HEIGHT PROPOSED: 30'-00"

NOTE: ALL STRUCTURES WILL BE FIRE SPRINKLERED

AREA SCHEDULE (F.A.R. (GROSS))				
UNIT NUMBER	UNIT DESCRIPTION	AREA (SF)		
UNIT 1 & 4	3 BR/ 3.5 BATH + BONUS	1,748 X 2		
UNIT 2 & 5	3 BR/ 2.5 BATH + BONUS	1,598 X 2		
UNIT 3 & 6	3 BR/ 2.5 BATH	1,631 X 2		
		GRAND TOTAL: 9,964 SF		

OPEN SPACE AREA TABULATION					
	1ST LEVEL 2ND LEVEL 3RD LEVEL TOTAL				
UNIT 1	413 SF	113 SF	0 SF	526 SF	
UNIT 2	218 SF	149 SF	0 SF	367 SF	
UNIT 3	802 SF	75 SF	202 SF	1,079 SF	
UNIT 4	413 SF	105 SF	0 SF	518 SF	
UNIT 5	218 SF	158 SF	0 SF	376 SF	
UNIT 6	802 SF	75 SF	215 SF	1,092 SF	

GRAND TOTAL PRIVATE OPEN SPACE ON LOT: 3.958 SF COMMON OPEN SPACE ON LOT: 679 SF

> (F) FIRE HYDRANT @105 FROM PROPERTY LINE

> > SUBJECT PROPERTY

BIKE PARKING TABULATION: 2 INDOOR BIKE RACK PER UNIT 1,2,4 & 5 = 8 SPACES

1 INDOOR BIKE RACK PER UNIT 3 & 6 = 2 SPACES OUTDOOR GUEST BIKE RACK = 4 SPACES TOTAL BIKE RACKS ON SITE = 14 SPACES

Forman Doris CPA O

ARCHITECTURAL INDEX

0.0	COVER SHEET
0.1	EXISTING STRUCTURES PHOTOS

SIDEWALK CONTEXT PHOTOS NEIGHBORHOOD CONTEXT PHOTOS UNIT DESCRIPTIONS & AREA TABULATIONS A0.4

A0.5 FAMILY FRIENDLY COMPLIANCE WASTE MANAGEMENT PLAN

A0.7 FIRE EGRESS PLAN EXISTING/ DEMOLITION PLAN A1.0

PROPOSED SITE PLAN LANDSCAPE PLAN

PARKING PLAN A2.1.3 (E) SITE TREES' PROTECTION ZONES

A2.1.4 SITE ELEVATION PROPOSED 1ST STORY PLAN

A2.3 PROPOSED 2ND STORY PLAN A2 4 PROPOSED 3RD STORY PLAN A2.5 PROPOSED ROOF PLAN

PROPOSED EAST/WEST ELEVATIONS PROPOSED NORTH/SOUTH ELEVATIONS PROPOSED COMMON DRIVE ELEVATIONS A3.2

A4.1 SECTIONS

UNIT 1 & 4 FURNITURE PLANS UNIT 2 & 5 FURNITURE PLANS A5.1

UNIT 3 & 6 FURNITURE PLANS A5.2 RENDERED ELEVATIONS WEST/ FAST

A6.1 RENDERED ELEVATIONS SOUTH/NORTH RENDERED COMMON DRIVEWAY

3D VIEW OF FRONT ENTRY A6.3 3D VIEW OF FRONT ENTRY A6.4

3D VIEW FROM DOYLE ST A6.6 3D VIEW OF COMMON ALLEY

3D VIEW COMMON OPEN SPACE



studio 🛚 architecture 5621 LOWELL STREET, OAKLAND, CA 94608 OFFICE: 510.595.6744

baran 🛭

DOYL **EMERYVILLE CA 94608** 5880 ∞ 9 28.

No.	Description	Date

COVER SHEET

Project Number 19TH SEPTEMBER 2017 MS

GENERAL NOTES

2016 CALIFORNIA RESIDENTIAL CODE WITH EMERYVILLE AMENDMENTS 2016 CALIFORNIA MECHANICAL CODE WITH EMERYVILLE AMENDMENTS

2016 CALIFORNIA PLUMBING CODE WITH EMERYVILLE AMENDMENTS

2016 CALIFORNIA ELECTRICAL CODE WITH EMERYVILLE AMENDMENTS

2016 CALIFORNIA ENERGY CODE WITH EMERYVILLE AMENDMENTS

2016 CALIFORNIA GREEN BUILDING STANDARDS CODE

APPLICABLE CODES

AND CONSTRUCTION OF 6 NEW SINGLE FAMILY CONDOS



DEMOLISH OF 4 EXISTING RESIDENTIAL UNITS (2 LEGAL AND 2 ILLEGAL)

SCOPE OF WORK

MAP











EMERYVILLE CA 94608

5876 & 5880 DOYLE

EXISTING STRUCTURES PHOT<u>OS</u>

Project Number 19TH SEPTEMBER 2017

A0.1

SOUTH STRUCTURE LOOKING EAST

NORTH STRUCTURE LOOKING EAST

CENTER DRIVEWAY LOOKING EAST





NORTH STRUCTURE LOOKIN NORTH (2)

CENTER DRIVEWAY LOOKING WEST

LARGE SHED LOOKING NORTH EAST

SOUTH STRUCTURE LOOKING NORTH

NORTH STRUCTURE LOOKING NORTH (1)







SOUTH STRUCTURE LOOKING NORTHWEST

SOUTH STRUCTURE LOOKING WEST



SOUTH STRUCTURE LOOKING SOUTHEAST (2)

SOUTH STRUCTURE LOOKING SOUTHEAST (1)

SIDEWALK **CONTEXT PHOTOS**

Project number	Project Number
Date	19TH SEPTEMBER 2017
Drawn by	KSA
Checked by	K STOCKTON

A0.2







DOYLE ST LOOKING SOUTH EAST DOYLE ST LOOKING NORTH EAST (1)

DOYLE ST LOOKING NORTH EAST (2)

SOUTHERN NEIGHBOR FROM PARKING LOT









DOYLE ST LOOKING SOUTH (1)	DOYLE ST LOOKING SOUTH (2)	

DOYLE ST LOOKING NORTH (1)

DOYLE ST LOOKING NORTH (2)









59TH STREET LOOKING EAST (1)	59TH STREET LOOKING EAST

59TH STREET LOOKING WEST (2)

ST (2)

59TH STREET LOOKING WEST (1)







5875 DOYLE ST. (ACROSS STREET NEIGHBOR)

LOOP 22 APARTMENTS , 5801 DOYLE ST



EMERYVILLE CA 94608

5876 & 5880 DOYLE

NEIGHBORHOOD **CONTEXT PHOTOS**

Project Number 19TH SEPTEMBER 2017

A0.3

1295 59TH ST (NORTHERN NEIGHBOR) 5874 DOYLE ST (SOUTHERN NEIGHBOR)

5875 DOYLE ST. (ACROSS STREET NEIGHBOR)





TOWNHOUSE BAR & GRILL, 5872 DOYLE ST






COMMUNITY GARDEN @ 59TH & DOYLE



NATIONAL HOLISTIC INSTITUE @ 59TH & DOYLE

5856 DOYLE ST 5820 DOYLE ST

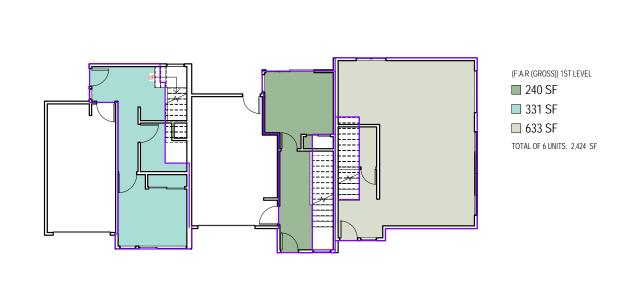

AREA SCHEDULE (F.A.R. (GROSS)) UNIT NUMBER AREA (SF) 1,748 X 2 UNIT 1 & 4 UNIT 2 & 5 1,598 X 2 UNIT 3 & 6 1,631 X 2

GRAND TOTAL: 9,964 SF



& 5880 DOYLE EMERYVILLE CA 94608 2876

No.	Description	Date



Drawn by Checked by

A0.4

As indicated

MS

1 1ST LEVEL (0'-8") SCALE: 1/8" = 1'-0"		
		(F.A.R (GROSS)) 2ND LEVEL 554 SF 557 SF 620 SF TOTAL OF 6 UNITS: 3,441 SF
2 2ND LEVEL (9'-8") SCALE: 1/8" = 1'-0"		
		(F.A.R (GROSS)) 3RD LEVEL 438 SF 797 SF 801 SF TOTAL OF 6 UNITS: 4,152 SF

3RD LEVEL (20'-6") SCALE: 1/8" = 1'-0"

FAMILY-FRIENDLY DESIGN GUIDELINES, SITE AND BUILDING DESIGN

FFD ID	GUIDELINE DESCRIPTION	PROPOSED DESIGN
J-41	PROVIDE UNITS WITH TWO, THREE OR MORE BEDROOMS.	ALL UNITS ARE 3 BEDROOM.
J-42	IN HIGH DENSITY HOUSING, INCLUDE A VARIETY OF UNIT TYPES.	UNITS VARY IN BATHROOM COUNT AND LAYOUT
J-43	PLACE AND CONFIGURE UNITS TO RELATE WELL TO QUIET AND NOISY STREETS, ON-SITE OPEN SPACE AND EACHOTHER, AS SOWN IN THE UNIT ADJACENCY DIAGRAM.	UNITS ARE NOT ADJECENET TO NOISY STREETS
J-44	SITUATE AS MANY FAMILY-ORIENTED UNITS AS POSSIBLE ADJACENT TO OPEN SPACES DESIGNED AND LANDSCAPED TO CREATE ACTIVE PLAY AREA AND OPPERTUNITIES FOR GATHERING AND QUIET RESPITE.	ALL SIX UNITS HAVE DIRECT ACCESS TO PRIVATE AND SHARED OPEN SPACES THAT ARE LANDSCAPED AND SUITABLE FOR ACTIVE PLAY
J-45	PROVIDE AMPLE EXTERIOR PLAY AREA THAT ARE SAFE AND VISIBLE FROM MAJOR SPACES IN HOMES, WITH A VARIETY OF AGE-APPROPRIATE EQUIPMENT	ALL OPEN SPACES CAN BE DIRECTLY SUPERVISED FROM THE LIVING SPACES. OPEN SPACES ARE LARGE TO ACCOMADATE PLAY EQUIPMENT
J-46	DESIGN VISIBLE PLACES WHERE PRE-TEENS AND TEENS WILL WANT TO GATHER TOGETHER	SAME COMMENT AS J-45
J-47	IN LARGE PROJECTS (E.G. OVER A HUNDRED UNITS)	DOES NOT APPLY
J-48	DESIGNATE PARKING NEAR HALLWAYS AND ELEVATORS	GARAGE LOCATED ADJACENT TO HALLWAY IN UNIT 1,2,4 $\&$ 5. PARKING LOCATED ADJACENT TO FRONT DOOR FOR UNIT 3 $\&$ 6
J-49	PROVIDE MORE BICYCLE PARKING THAN THE CODE REQUIRES, WITH SPACE FOR LONGER FAMILY BICYCLES AND TRAILERS.	SEVEN BIKE PARKING SPACES REQUIRED BY CODE; SPACE FOR BIKES PROVIDED IN EACH UNIT (TOTAL OF 10 INDOOR SPACES) PLUS 4 GUEST SPACES OUTDOORS
J-50	PROVIDE AMPLE IN-UNIT OR COMMON LAUNDRY AREAS.	ALL SIX UNITS HAVE IN-UNIT WASHER AND DRYER FACILITY

FAMILY-FRIENDLY DESIGN GUIDELINES, UNIT DESIGN

FFD ID	GUIDELINE DESCRIPTION	PROPOSED DESIGN
J-51	FRONT DOORS SHOULD NOT ENTER DIRECTLY INTO A ROOM, BUT RATHER SHOULD ENTER INTO A TRANSITIONAL SPACE, WHICH COULD BE AN ENCLOSED FOYER.	ALL FRONT DOORS ENTER INTO A FOYER.
J-52	PROVIDE INDOOR SPACE NEAR THE ENTRY FOR TRICYCLES, STROLLERS, OUTDOOR TOYS, ETC,. WHERE PARKED ITEMS WILL NOT OBSTRUCT CIRCULATION.	CLOSET PROVIDED UNDER STAIRS IN ENTRY FOYER
J-53	PROVIDE ONLY ONE MASTER SUITE. OTHER BEDROOMS SHOULD HAVE ACCESS TO A COMMON BATHROOM. IN THREE-BEDROOM UNITS PROVIDE AT LEAST TWO FULL BATHROOMS.	ALL UNITS HAVE ONE MASTER SUITE. UNITS 1 & 4 HAVE THREE FULL BATHROOMS, UNITS 2,3,4, & 5 HAVE TWO FULL BATHROOMS.
J-54	SEPERATE SLEEPING AREAS FROM LIVING AREAS.	IN UNIT 1,2,4 & 5 LIVING AREAS ARE ON THE SECOND FLOOR AND BEDROOMS ARE ON THE THIRD FLOOR. IN UNITS 3 & 6 LIVING AREAS ARE ON THE FIRST FLOOR AND BEDROOMS ARE ON THE SECOND AND THIRD FLOOR.
J-55 (a)	PROVIDE EACH BEDROOM WITH ACCESS TO A FULL BATHROOM WITHOUT GOING THROUGH LIVING AREAS.	DONE.
J-55 (b)	PROVIDE A BATHTUB IN THE UNIT.	DONE.
J-55 (c)	PROVIDE AT LEAST A HALF BATH ON THE FLOOR WITH THE LIVING ROOM , DINING AREA AND KITCHEN.	DONE.
J-56 (a)	THE DINING AREA SHOULD HAVE ENOUGH ROOM FOR A DINING TABLE WITH ALL HOUSE HOLD MEMBERS SEATING AROUND IT PLUS CIRCULATION.	SEE (A2.2 & A2.3) FOR FURNITURE LAYOUT IN PLANS.
J-56 (b)	THE LIVING AREA SHOULD HAVE ENOUGH ROOM FOR SEATING ALL FAMILY MEMBERS PLUS OTHER FURNITURE AND CIRCULATION.	SEE (A2.2 & A2.3) FOR FURNITURE LAYOUT IN PLANS.
J-57	IN UNITS NEAR PLAY AREA, PROVIDE WINDOWS THAT ALLOW FOR SUPERVISION OF CHILDREN OUTDOORS.	ALL UNITS HAVE WINDOWS FACING THEIR PRIVATE OPEN AREA AND THE SHARED OPEN AREA.
J-58	HALLWAYS IN UNITS SHOULD BE WELL LIGHTED AND WIDE ENOUGH FOR CHILDREN TO PLAY IN.	HALLWAYS ARE WIDER THAN CODE REQUIREMENTS. HALLWAYS HAVE SKYLIGHTS AND WINDOW BY THE STAIRS.
J-59	PROVIDE SPACE THAT CAN CHANGE USE AS CHILDREN GROW, SUCH AS FROM TODDLER PLAY TO HOMEWORK TO MUSIC MAKING TO GATHERING.	BONUS ROOM PROVIDED IN UNITS 1 & 4. ALL LIVING SPACES HAVE A FLEXIBLE OPEN LAYOUT THAT CAN BE REARRANGED WITH TIME.
J-60	FOR UNITS WITH OTHER UNITS BELOW	DOES NOT APPLY.
J-61	DESIGN UNITS WITH INFANT AND TODDLER SAFETY IN MIND (E.G. STAIRS THAT EASILY ACCEPT TODDLER GATES, NO GLASS ROOM DIVIDERS, AND ABBILITY TO ADD CHILD SAFETY DEVICES OR WINDOW LOCKS TO PREVENT TODDLERS FROM CLIMBING OUT OF WINDOW)	RESIDENCES WILL EASILY ACCEPT ALL CHILD SAFETY FEATURES.




5876 & 5880 DOYLE EMERYVILLE CA 94608

No.	Description	D

FAMILY FRIENDLY COMPLIANCE

Project Number 19TH SEPTEMBER 2017 Drawn by Checked by

A0.5

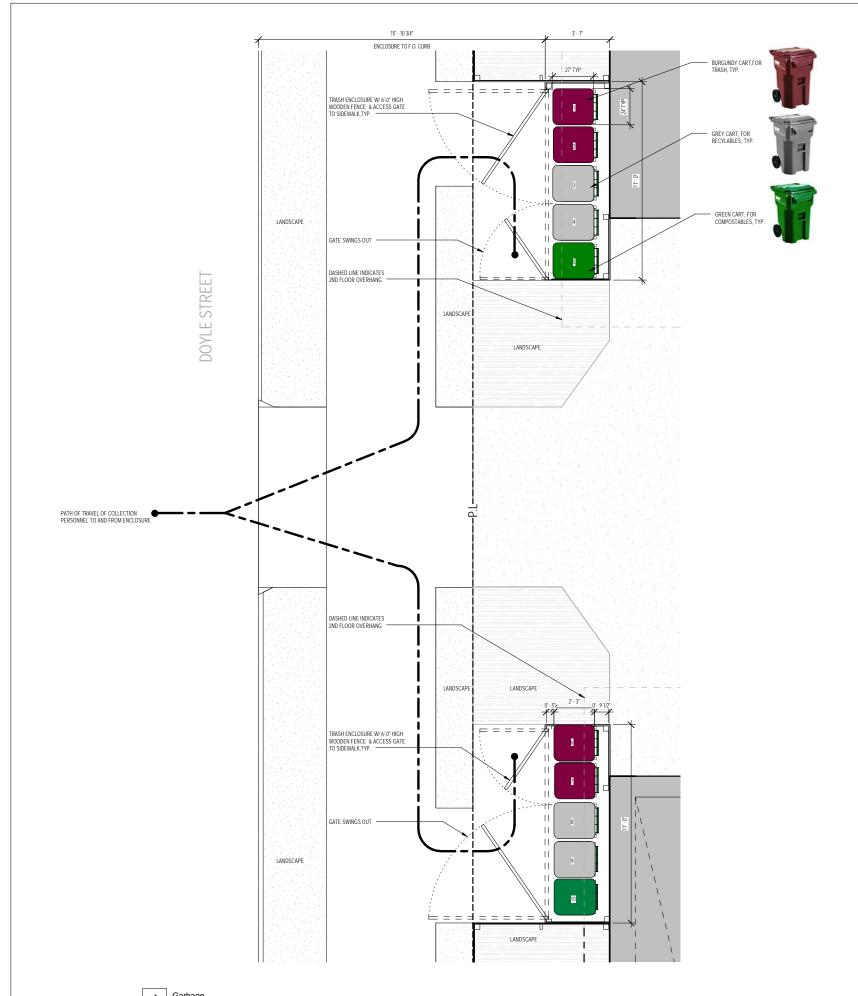

NOTE: ALL CARTS ARE 64 GALLON CAPACITY CARTS (42"H X 24"W X 27"D)

NOTE:
ENCLOSURES TO BE LOCKED BY "MASTER" LOCK PROVIDED BY THE HAULER TO RESIDENTS AND HAULER.



5876 & 5880 DOYLE EMERYVILLE CA 94608


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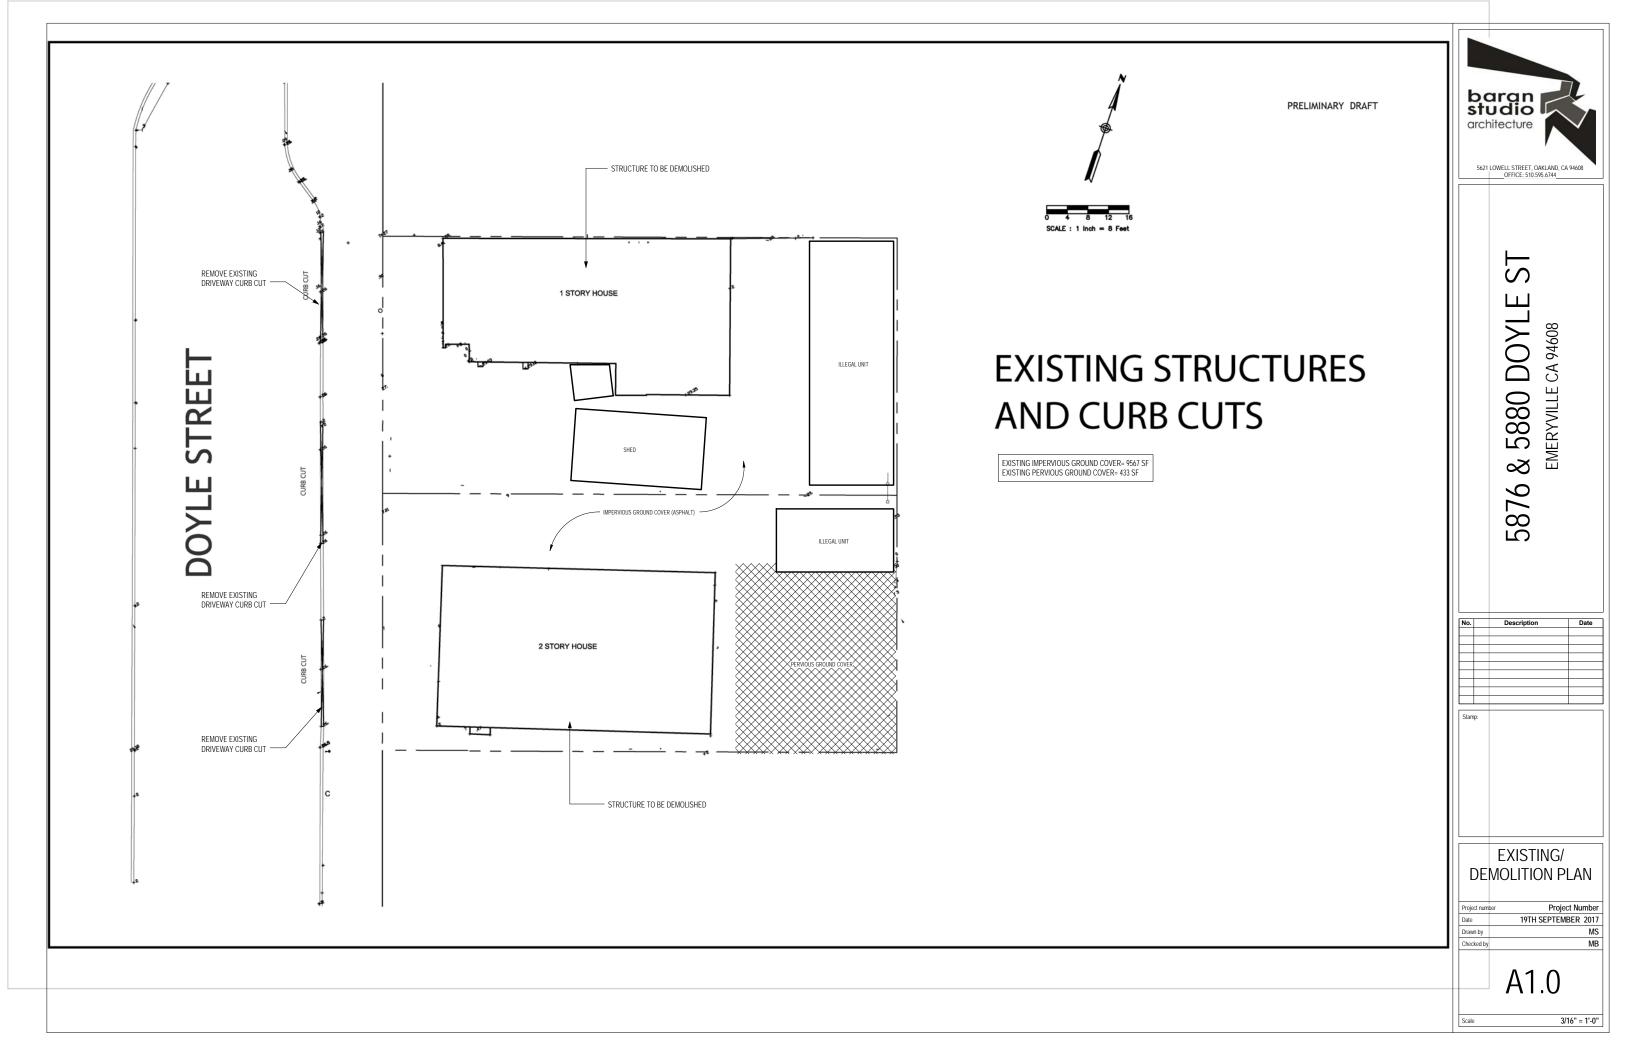
WASTE
MANAGEMENT PLAN


Project Number 19TH SEPTEMBER 2017 Drawn by MS

A0.6

3/8" = 1'-0"



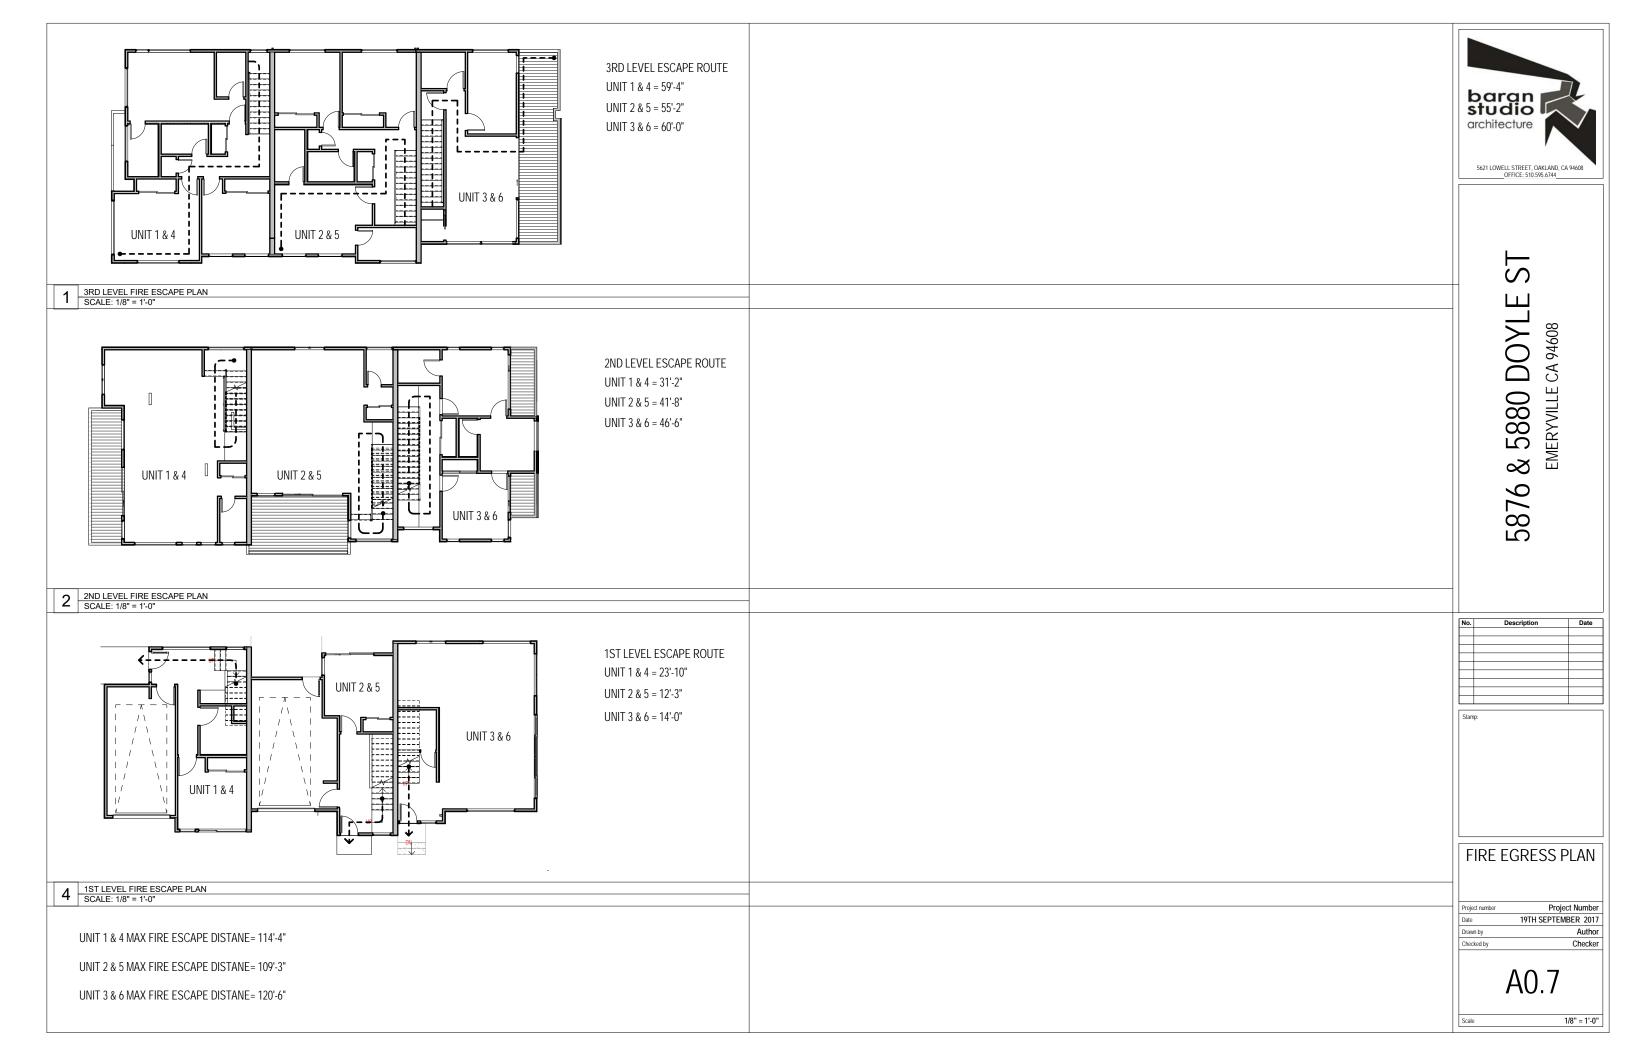

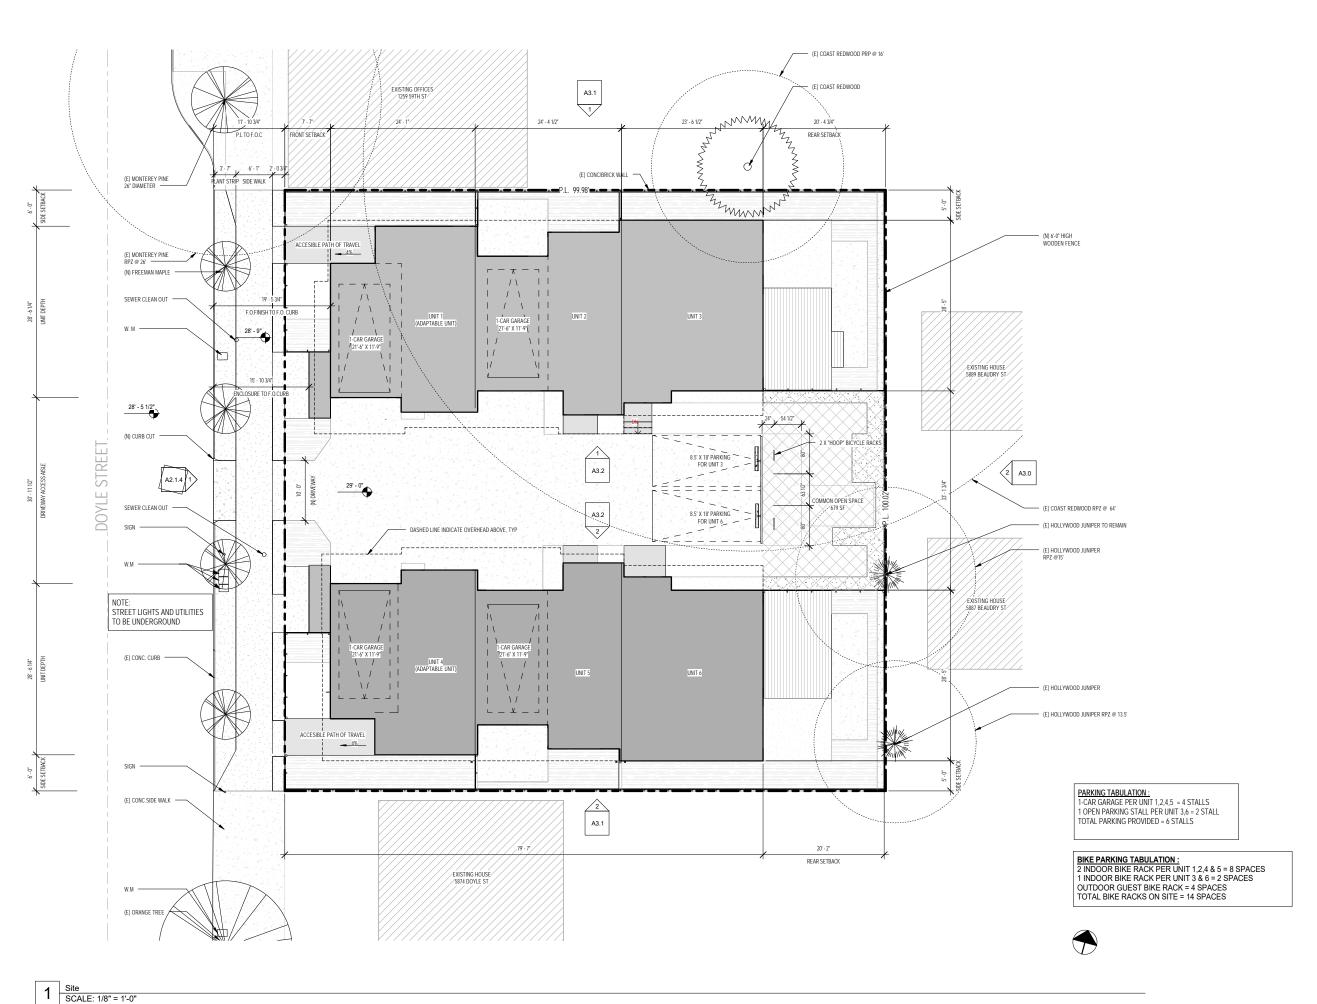



5876 & 5880 DOYLE STERMENT STATE STATE OF 194608

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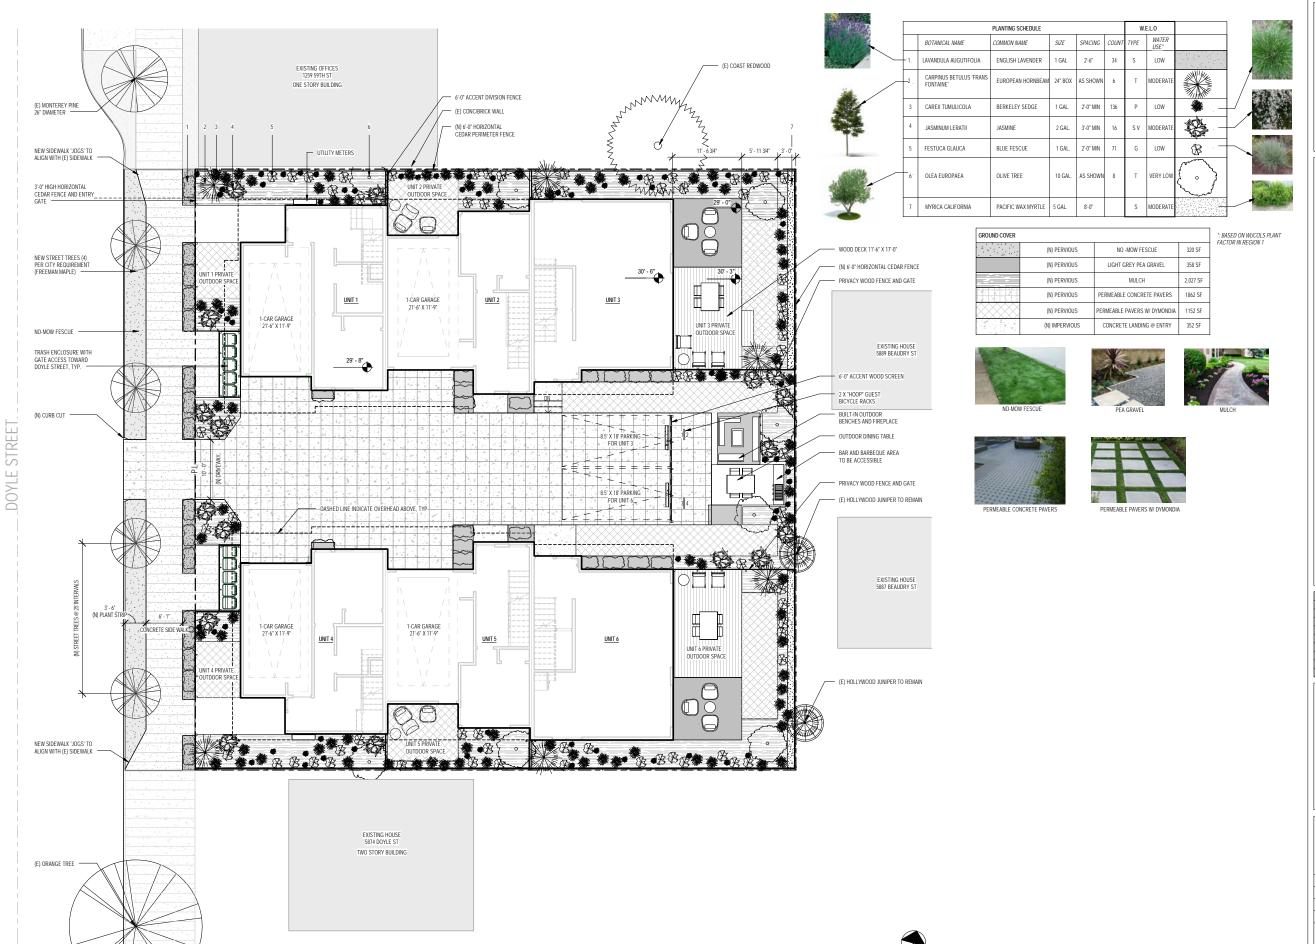
Star

PROPOSED SITE PLAN

Project Number
19TH SEPTEMBER 2017
MS
MB

A2.0

As indicated





No.	Description	Date

Star

LANDSCAPE PLAN

 Project number
 Project Number

 Date
 19TH SEPTEMBER 2017

 Drawn by
 MS

 Checked by
 MR

A2.1

As indicated

LANDSCAPE PLAN SCALE: 1/8" = 1'-0"



LAN	DSCAPE SCHEE	DULE		
		LANDSCAPE TYPE	AREA	PERCENTAGE OF GROUND AREA (10,000 SF)
		SOFTSCAPE	2296 SF	23%
П		PERVIOUS HARDSCAPE	3,230 SF	33.4 %
		IMPERVIOUS HARDSCAPE	437 SF	4.3 %
		STREET SOFTSCAPE	320 SF	NOT ON PROPERTY
		→ LANDSCAPE TOTAL:	5,955 SF	59.6%

WELO (WATER EFFICIENT LANDSCAPING ORDINANCE):

PER SECTION 9-4.602 OF THE EMERYVILLE MUNICIPAL CODE, NEW LANDSCAPING FROM 500 SF UP TO 2500 SF SHALL COMPLY WITH THE PRESCRIPTIVE REQUIREMENTS FOR SMALLER LANDSCAPES.

1.SELECTED CLIMATE ADAPTED PLANTS REQUIRE AVERAGE WUCOLS PLANT FACTOR OF 0.3 (OCCASIONAL,LITTLE OR NO SUMMER WATER REQUIRED). (SEE A2.1)

2. AT LEAST 6 CUBIC YARDS OF COMPOST PER 1000 SF SHALL BE INCORPORATED IN THE TOP 6 INCHES OF SOIL.

3.REQUIRED TREES SHALL HAVE ADEQUATE ROOTABLE SOIL VOLUME.

4. THE PROPOSED PLANTING SHALL BE WATERED BY AN AUTOMATIC IRRIGATION SYSTEM THAT USES EVAPOTRANSPIRATION OR SOIL MOISTURE SENSOR DATA. THE SYSTEM SHALL UTILIZE A RAIN SENSOR.

5. IRRIGATION CONTROLLERS SHALL BE A TYPE WHICH DOES NOT LOSE PROGRAMMING DATA IN THE EVENT THE PRIMARY POWER SOURCE IS INTERRUPTED.

6.PRESSURE REGULATORS SHALL BE INSTALLED ON THE IRRIGATION SYSTEM.

7.MANUAL SHUT-OFF VALVES SHALL BE INSTALLED CLOSE TO THE WATER SUPPLY.

8.ALL IRRIGATION EMISSION DEVICES MUST MEET THE REQUIREMENTS SET IN THE AMERICAN NATIONAL STANDARDS INSTITUTE (ANSI) STANDARDS, ASABE/ICC 802-2014.

baran	Choose city ▶ Plant search ▶ My Plant List Region 1	ı
Plant List: 7 Plants		
WUCOLS Region 1		

Return to plant search	Type	Botanical Name	Common Name	Water Use
Download plant list	PN	Carex tumulicola	Berkeley sedge	Low
Go to Drip Worksheet for clay soil	T	Carpinus betulus	European hornbeam	Moderate
Go to Drip Worksheet for loam soil	G	Festuca glauca	blue fescue	Low
Go to Drip Worksheet for sandy soil	V	Jasminum Ieratii	jasmine (leratii)	Moderate
	S	Lavandula spp., cvs.	lavender	Low
	SN	Myrica californica (See Morella californica)		
	T	Olea europaea	olive	Very Low



5876 & 5880 DOYLE STERMERYVILLE CA 94608

No.	Description	Dat

Stamp

W.E.L.O

 Project number
 Project Number

 Date
 19TH SEPTEMBER 2017

 Drawn by
 Author

A2.1.1

As indicated

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LANDSCAPE AREA DIAGRAM SCALE: 1/8" = 1'-0"

DOYLE STREET






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PARKING PLAN

Project Number 19TH SEPTEMBER 2017 Author

1/8" = 1'-0"

PARKING PLAN
SCALE: 1/8" = 1'-0"



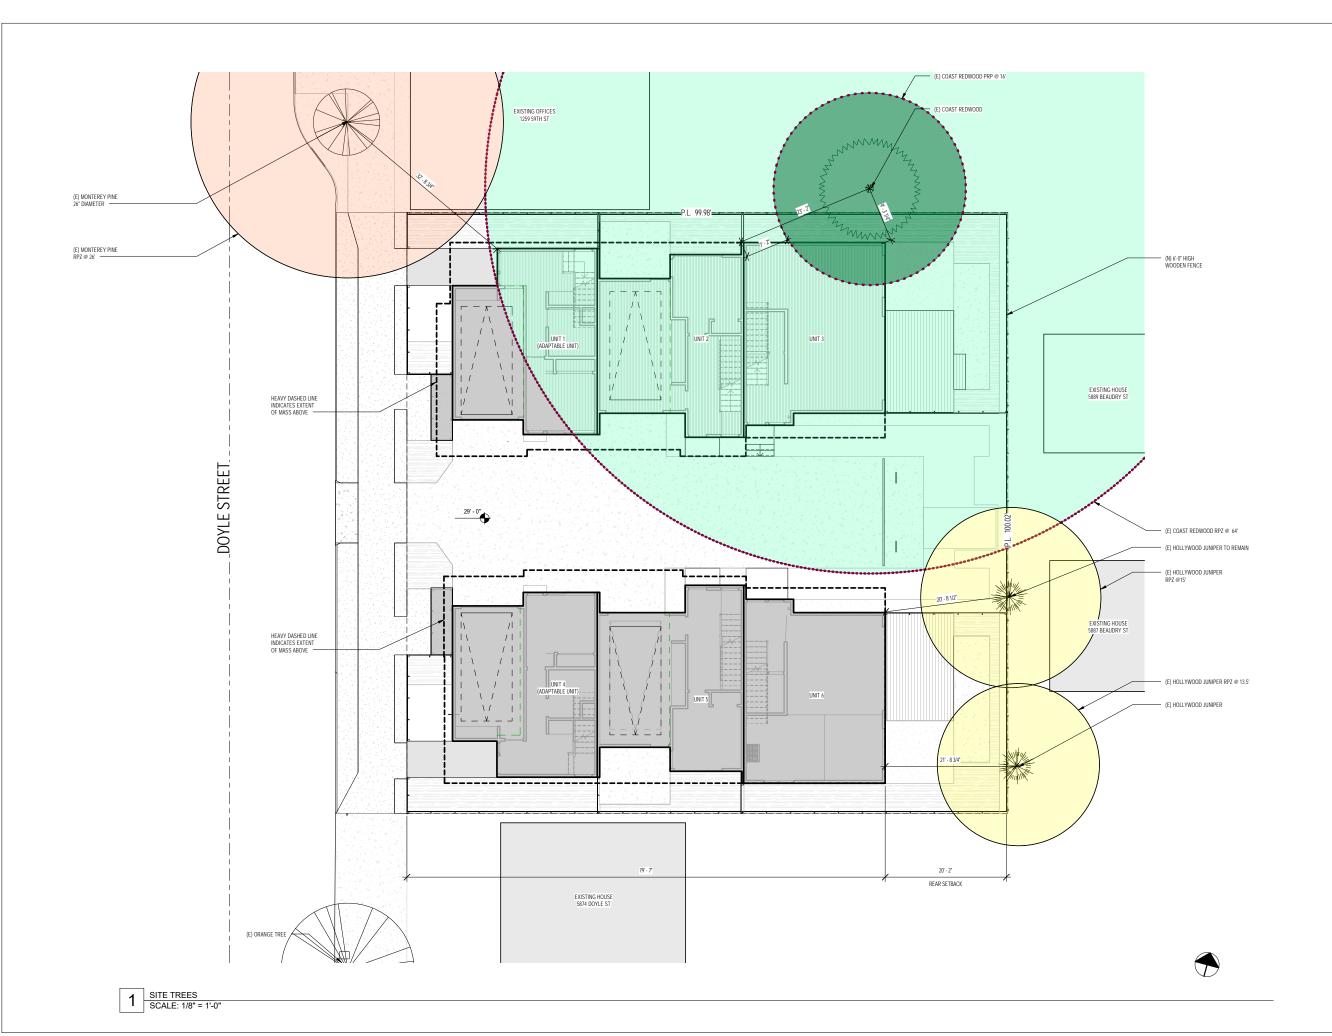

No.	Description	Date
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		_

15

(E) SITE TREES' PROTECTION ZONES

 Project number
 Project Number

 Date
 19TH SEPTEMBER 2017

 Drawn by
 Author

 Checked by
 Checker

A2.1.3

1/8" = 1'-0"





OPEN SPACE LEGEND

PRIVATE GROUND OPEN SPACE

OPI	EN SPACE AF	REA TABULAT	ION	
	1ST LEVEL	2ND LEVEL	3RD LEVEL	TOTAL
UNIT 1	413 SF	113 SF	0 SF	526 SF
UNIT 2	218 SF	149 SF	0 SF	367 SF
UNIT 3	802 SF	75 SF	202 SF	1,079 SF
UNIT 4	413 SF	105 SF	0 SF	518 SF
UNIT 5	218 SF	158 SF	0 SF	376 SF
UNIT 6	802 SF	75 SF	215 SF	1,092 SF

GRAND TOTAL PRIVATE OPEN SPACE ON LOT: 3,958 SF




ST 5876 & 5880 DOYLE EMERYVILLE CA 94608

No.	Description	Date

PROPOSED 1ST STORY PLAN

19TH SEPTEMBER 2017

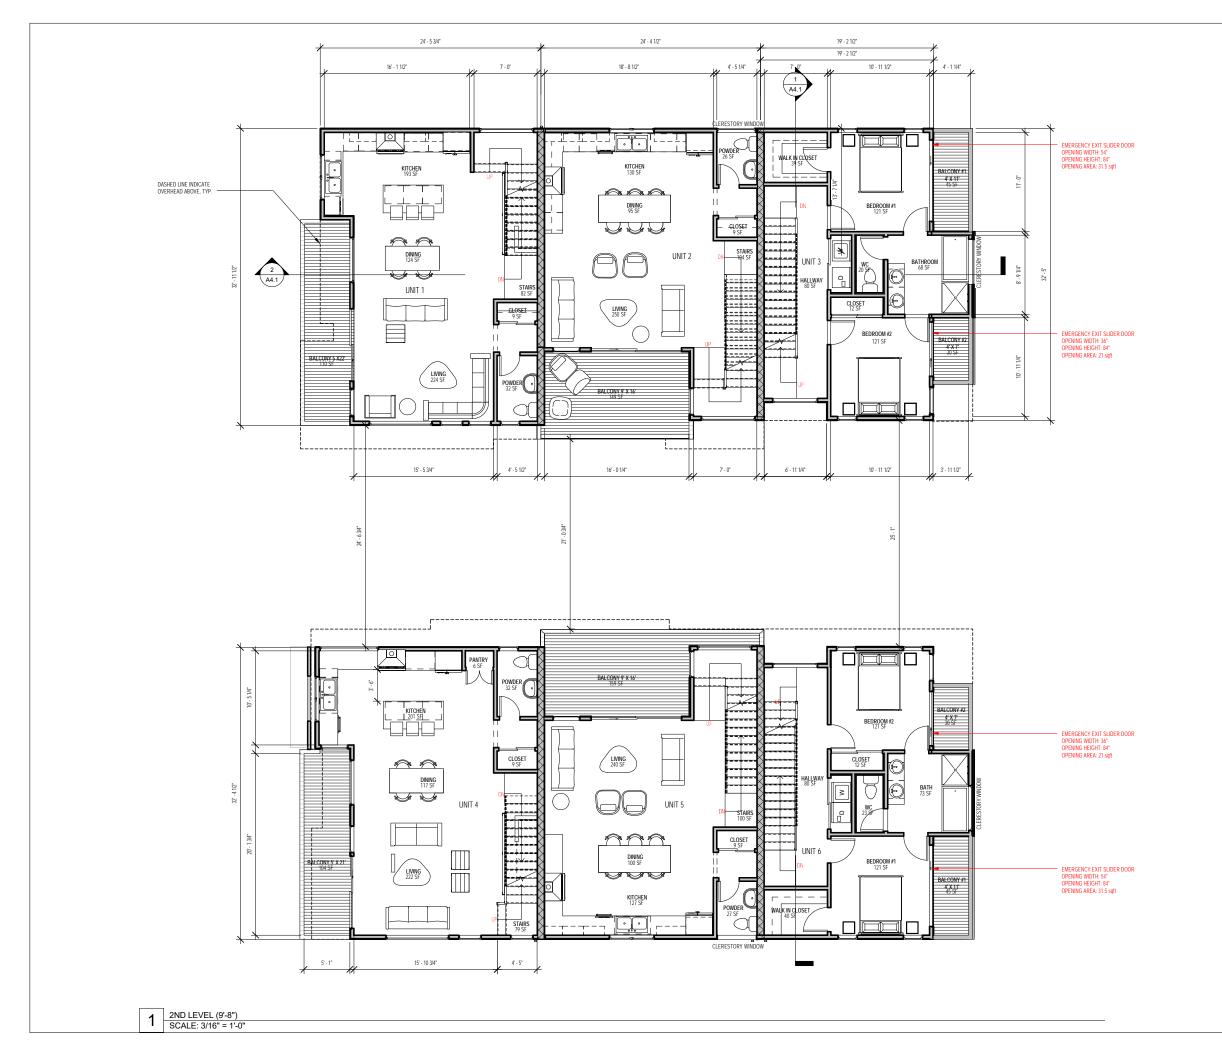

OPEN SPACE LEGEND

PRIVATE GROUND OPEN SPACE

BALCONY

OPEN SPAC	E AREA TABI	JLATION	
1ST LEVEL	2ND LEVEL	3RD LEVEL	TOTAL
413 SF	113 SF	0 SF	526 SF
218 SF	149 SF	0 SF	367 SF
802 SF	75 SF	202 SF	1,079 SF
413 SF	105 SF	0 SF	518 SF
218 SF	158 SF	0 SF	376 SF
802 SF	75 SF	215 SF	1,092 SF
	1ST LEVEL 413 SF 218 SF 802 SF 413 SF 218 SF	1ST LEVEL 2ND LEVEL 413 SF 113 SF 218 SF 149 SF 802 SF 75 SF 413 SF 105 SF 218 SF 158 SF	413 SF 113 SF 0 SF 218 SF 149 SF 0 SF 802 SF 75 SF 202 SF 413 SF 105 SF 0 SF 218 SF 158 SF 0 SF

GRAND TOTAL PRIVATE OPEN SPACE ON LOT: 3,958 SF



5876 & 5880 DOYLE ST EMERYVILLE CA 94608

No.	Description	Date

Star

PROPOSED 2ND STORY PLAN


 Project number
 Project Number

 Date
 19TH SEPTEMBER 2017

 Drawn by
 MS

 Checked by
 MB

A2.3

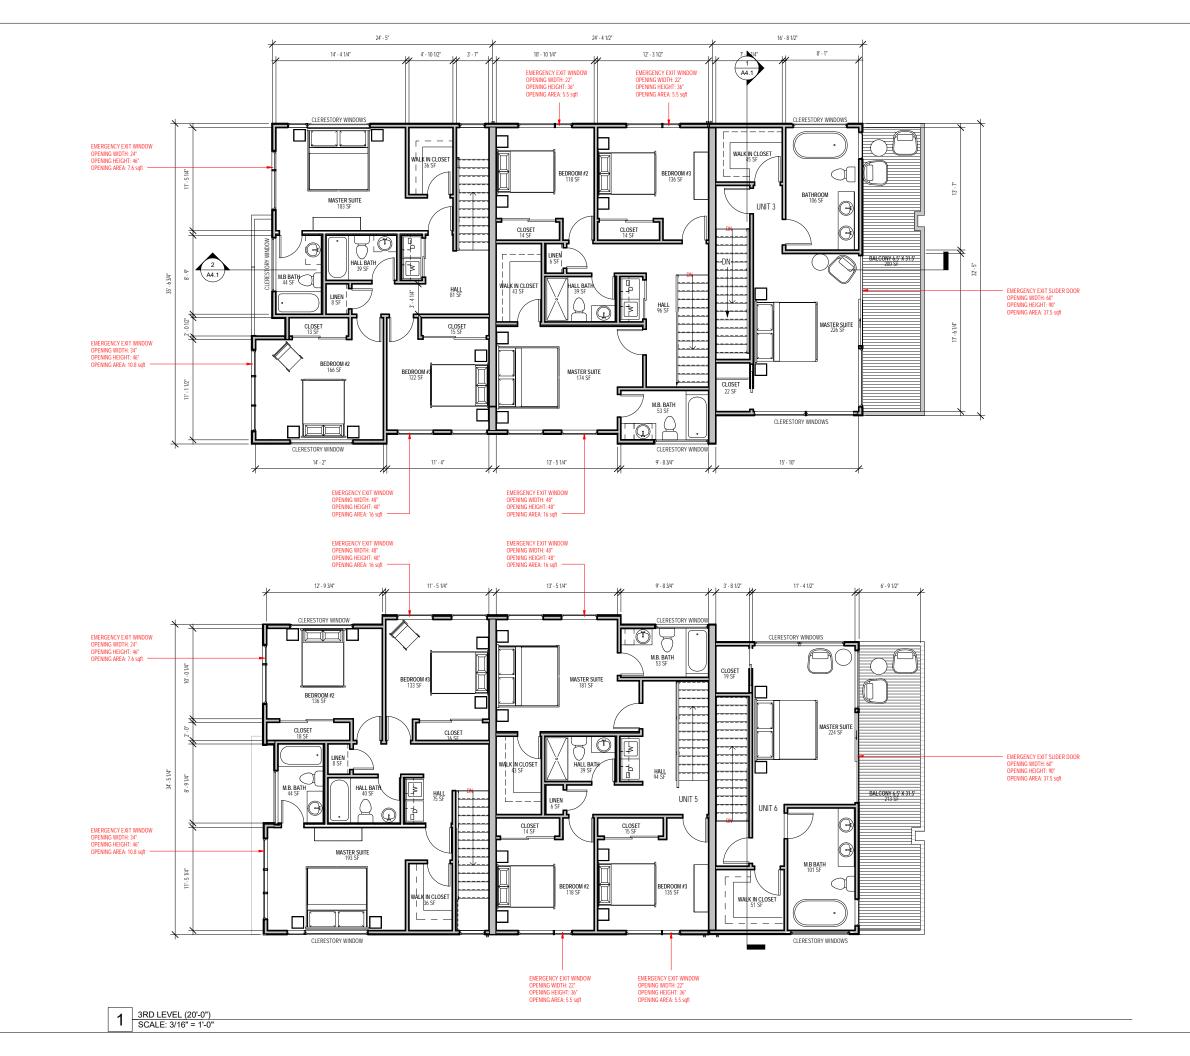

OPEN SPACE LEGEND

PRIVATE GROUND OPEN SPACE

BALCONY

OPE	EN SPACE AF	REA TABULAT	ION	
	1ST LEVEL	2ND LEVEL	3RD LEVEL	TOTAL
UNIT 1	413 SF	113 SF	0 SF	526 SF
UNIT 2	218 SF	149 SF	0 SF	367 SF
UNIT 3	802 SF	75 SF	202 SF	1,079 SF
UNIT 4	413 SF	105 SF	0 SF	518 SF
UNIT 5	218 SF	158 SF	0 SF	376 SF
UNIT 6	802 SF	75 SF	215 SF	1,092 SF

GRAND TOTAL PRIVATE OPEN SPACE ON LOT: 3,958 SF



5876 & 5880 DOYLE ST EMERYVILLE CA 94608

No.	Description	Date

Star

PROPOSED 3RD STORY PLAN


 Project number
 Project Number


 Date
 19TH SEPTEMBER 2017

 Drawn by
 MS

 Checked by
 MB

A2.4

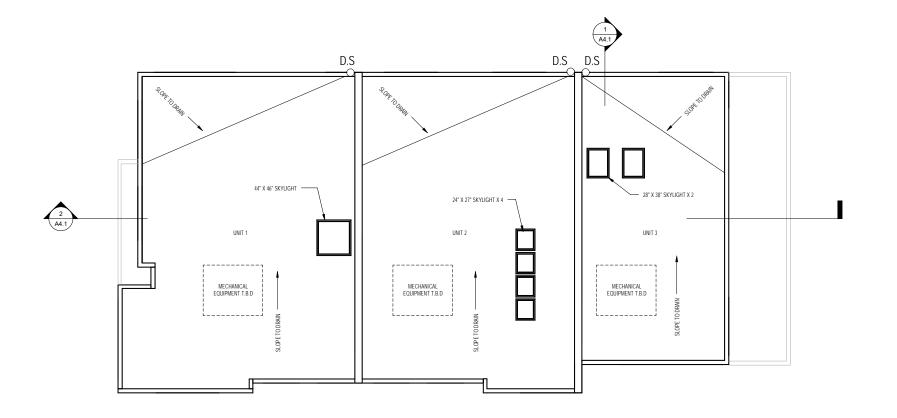

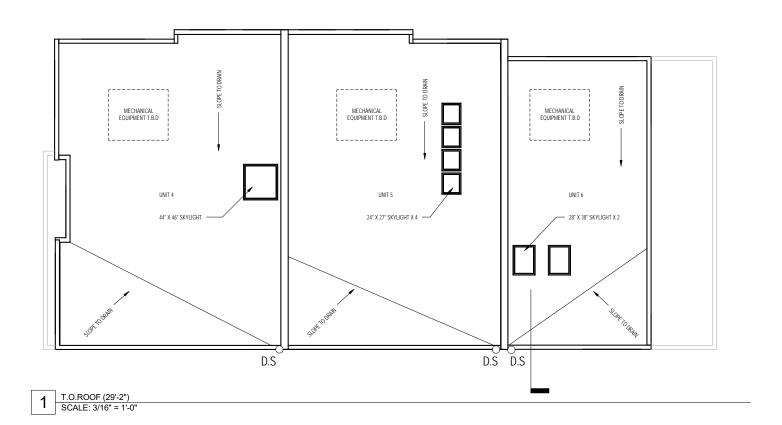



No.	Description	Date

Sta

PROPOSED ROOF PLAN

 Project number
 Project Number

 Date
 9TH AUGUST 2017

 Drawn by
 MS

 Checked by
 MB

A2.5





baran studio architecture

5621 LOWELL STREET, OAKLAND, CA 94608 OFFICE: 510.595.6744

5876 & 5880 DOYLE ST EMERYVILLE CA 94608

Description	
	Description

Star

PROPOSED EAST/WEST ELEVATIONS

Project number Project Number
Date 19TH SEPTEMBER 2017
Drawn by MS
Checked by MB

A3.0



NORTH
SCALE: 3/16" = 1'-0"



2 SOUTH SCALE: 3/16" = 1'-0"



5876 & 5880 DOYLE ST EMERYVILLE CA 94608

No.	Description	Da
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Star

PROPOSED NORTH/SOUTH ELEVATIONS

ELEVATIONS
Project number Project Number
Date 19TH SEPTEMBER 2017
Drawn by MS
Checked by MB

A3.1



Common Drive North Elevations
SCALE: 3/16" = 1'-0"



Common Drive South Elevation
SCALE: 3/16" = 1'-0"





ST 5876 & 5880 DOYLE EMERYVILLE CA 94608

PROPOSED **COMMON DRIVE ELEVATIONS**

Project Number 19TH SEPTEMBER 2017

A3.2

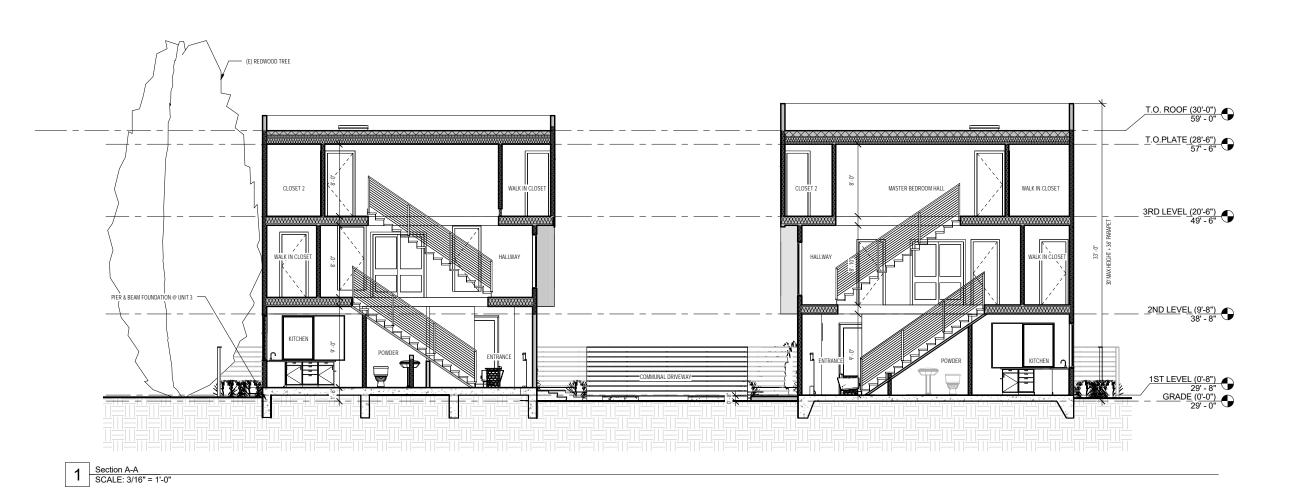

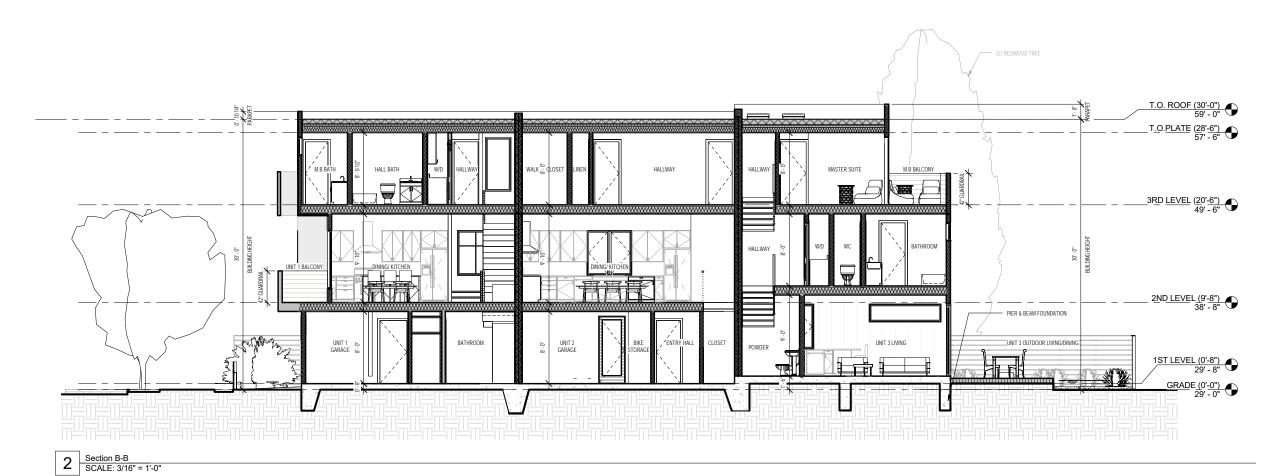





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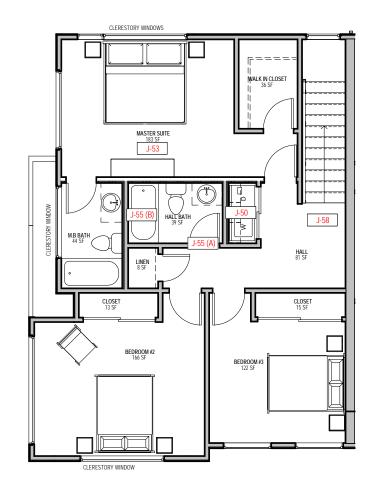
Star

SECTIONS

A4.1



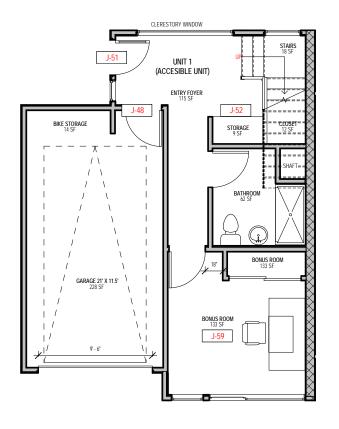

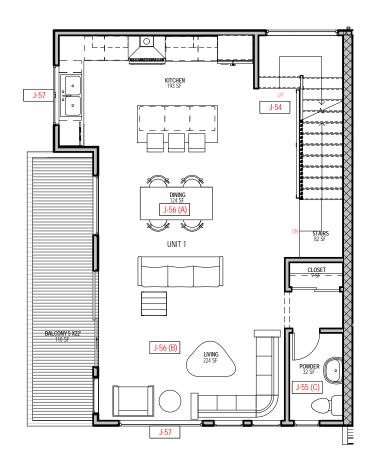

baran studio architecture

5621 LOWELL STREET, OAKLAND, CA 94608 OFFICE: 510.595.6744

5876 & 5880 DOYLE ST EMERYVILLE CA 94608

Date	Description	No.

Stamp:

UNIT 1 & 4
FURNITURE PLANS

 Project number
 Project Number

 Date
 19TH SEPTEMBER 2017

 Drawn by
 Author

 Checked by
 Checker

A5.0

1/4" = 1'-0"

1 | 1ST LEVEL- UNIT 1 & 4 | SCALE: 1/4" = 1'-0" | 2 | 2ND LEVEL- UNIT 1 & 4 | SCALE: 1/4" = 1'-0" | 3 | 3RD LEVEL- UNIT 1 & 4 | SCALE: 1/4" = 1'-0" | 3 | SCALE: 1/4" = 1'-0"

FAMILY- FRIENDLY DESIGN GUIDELINES, UNIT DESIGN (SEE A0.5 FOR ALL REQUIREMENTS)

DESIGNATE PARKING NEAR HALLWAYS AND ELEVATORS

PROVIDE AMPLE IN-UNIT OR COMMON LAUNDRY AREAS.

FRONT DOORS SHOULD NOT ENTER DIRECTLY INTO A ROOM, BUT RATHER SHOULD ENTER INTO A TRANSITIONAL SPACE, WHICH COULD BE AN ENCLOSED FOYER.

PROVIDE INDOOR SPACE NEAR THE ENTRY FOR TRICYCLES, STROLLERS, OUTDOOR TOYS, ETC,. WHERE PARKED ITEMS WILL NOT OBSTRUCT CIRCULATION.

PROVIDE ONLY ONE MASTER SUITE. OTHER BEDROOMS SHOULD HAVE ACCESS TO A COMMON BATHROOM. IN THREE-BEDROOM UNITS PROVIDE AT LEAST TWO FULL BATHROOMS.

SEPERATE SLEEPING AREAS FROM LIVING AREAS.

PROVIDE EACH BEDROOM WITH ACCESS TO A FULL BATHROOM WITHOUT GOING THROUGH LIVING AREAS.

J-55 (B) PROVIDE A BATHTUB IN THE UNIT.

PROVIDE AT LEAST A HALF BATH ON THE FLOOR WITH THE LIVING ROOM, DINING AREA AND KITCHEN.


155(A) THE DINING AREA SHOULD HAVE ENOUGH ROOM FOR A DINING TABLE WITH ALL HOUSE HOLD MEMBERS SEATING AROUND IT PLUS CIRCULATION.


155(8) THE LIVING AREA SHOULD HAVE ENOUGH ROOM FOR SEATING ALL FAMILY MEMBERS PLUS OTHER FURNITURE AND CIRCULATION.


IN UNITS NEAR PLAY AREA, PROVIDE WINDOWS THAT ALLOW FOR SUPERVISION OF CHILDREN OUTDOORS.

HALLWAYS IN UNITS SHOULD BE WELL LIGHTED AND WIDE ENOUGH FOR CHILDREN TO PLAY IN.

PROVIDE SPACE THAT CAN CHANGE USE AS CHILDREN GROW, SUCH AS FROM TODDLER PLAY TO HOMEWORK TO MUSIC MAKING TO GATHERING.

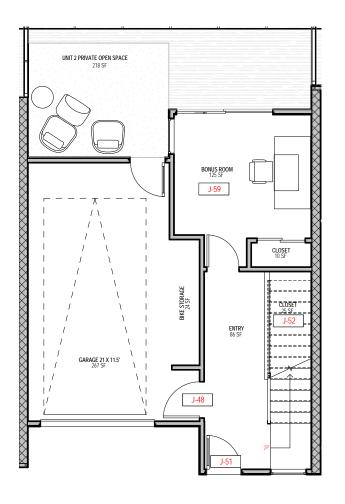

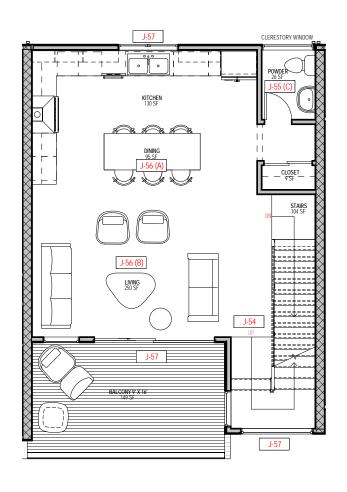

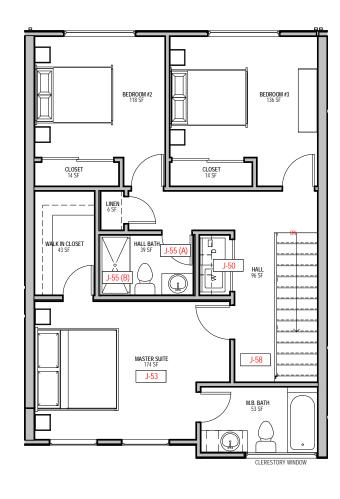



				INO	4
1	1ST LEVEL-UNIT 2 & 5 SCALE: 1/4" = 1'-0"	2ND LEVEL- UNIT 2 & 5 SCALE: 1/4" = 1'-0"	3RD LEVEL- UNIT 2 & 5 SCALE: 1/4" = 1'-0"] =	#
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FAMILY- FRIENDLY DESIGN GUIDELINES, UNIT DESIGN (SEE A0.5 FOR ALL REQUIREMENTS)

- DESIGNATE PARKING NEAR HALLWAYS AND ELEVATORS
- PROVIDE AMPLE IN-UNIT OR COMMON LAUNDRY AREAS.
- FRONT DOORS SHOULD NOT ENTER DIRECTLY INTO A ROOM, BUT RATHER SHOULD ENTER INTO A TRANSITIONAL SPACE, WHICH COULD BE AN ENCLOSED FOYER.
- PROVIDE INDOOR SPACE NEAR THE ENTRY FOR TRICYCLES, STROLLERS, OUTDOOR TOYS, ETC., WHERE PARKED ITEMS WILL NOT OBSTRUCT CIRCULATION.
- PROVIDE ONLY ONE MASTER SUITE. OTHER BEDROOMS SHOULD HAVE ACCESS TO A COMMON BATHROOM. IN THREE-BEDROOM UNITS PROVIDE AT LEAST TWO FULL BATHROOMS.
- SEPERATE SLEEPING AREAS FROM LIVING AREAS.
- PROVIDE EACH BEDROOM WITH ACCESS TO A FULL BATHROOM WITHOUT GOING THROUGH LIVING AREAS.
- J-55 (B) PROVIDE A BATHTUB IN THE UNIT.
- PROVIDE AT LEAST A HALF BATH ON THE FLOOR WITH THE LIVING ROOM, DINING AREA AND KITCHEN.
- THE DINING AREA SHOULD HAVE ENOUGH ROOM FOR A DINING TABLE WITH ALL HOUSE HOLD MEMBERS SEATING AROUND IT PLUS CIRCULATION.
- THE LIVING AREA SHOULD HAVE ENOUGH ROOM FOR SEATING ALL FAMILY MEMBERS PLUS OTHER FURNITURE AND CIRCULATION.
- J-57 IN UNITS NEAR PLAY AREA, PROVIDE WINDOWS THAT ALLOW FOR SUPERVISION OF CHILDREN OUTDOORS.
- HALLWAYS IN UNITS SHOULD BE WELL LIGHTED AND WIDE ENOUGH FOR CHILDREN TO PLAY IN.
- PROVIDE SPACE THAT CAN CHANGE USE AS CHILDREN GROW, SUCH AS FROM TODDLER PLAY TO HOMEWORK TO MUSIC MAKING TO GATHERING.

	No.	Description	Date
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Stamp

UNIT 2 & 5 FURNITURE PLANS


 Project number
 Project Number


 Date
 19TH SEPTEMBER 2017

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 Author


A5.1

1/4" = 1'-0"

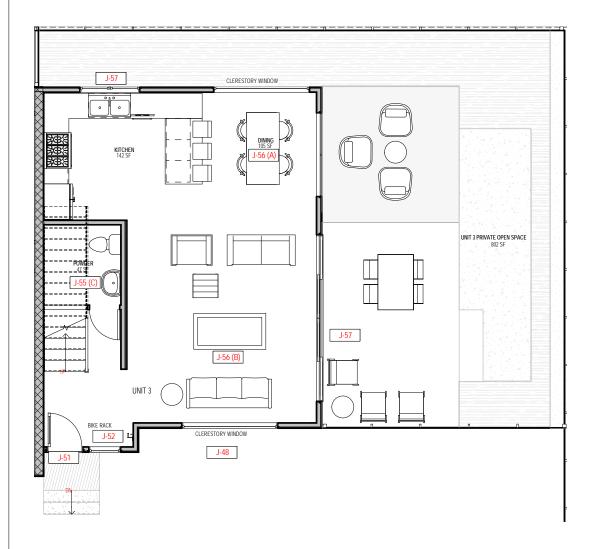

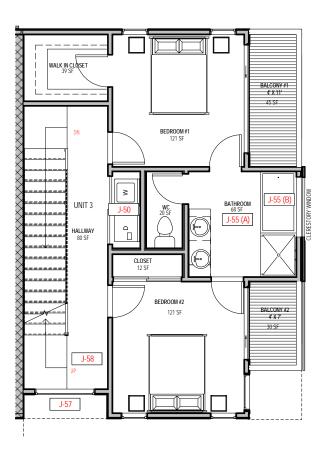

2 2ND LEVEL- UNIT 3 & 6 SCALE: 1/4" = 1'-0"

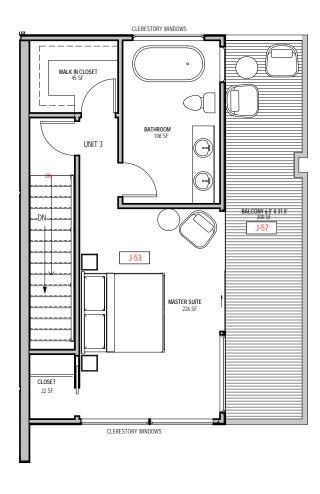

3 3RD LEVEL- UNIT 3 & 6 SCALE: 1/4" = 1'-0"



5876 & 5880 DOYLE ST EMERYVILLE CA 94608

No.	Description	Date

Stamp:

UNIT 3 & 6 FURNITURE PLANS

 Project number
 Project Number

 Date
 19TH SEPTEMBER 2017

 Drawn by
 Author

 Checked by
 Checker

A5.2

1/4" = 1'-0"

FAMILY- FRIENDLY DESIGN GUIDELINES, UNIT DESIGN (SEE A0.5 FOR ALL REQUIREMENTS)

DESIGNATE PARKING NEAR HALLWAYS AND ELEVATORS

PROVIDE AMPLE IN-UNIT OR COMMON LAUNDRY AREAS.

FRONT DOORS SHOULD NOT ENTER DIRECTLY INTO A ROOM, BUT RATHER SHOULD ENTER INTO A TRANSITIONAL SPACE, WHICH COULD BE AN ENCLOSED FOYER.

PROVIDE INDOOR SPACE NEAR THE ENTRY FOR TRICYCLES, STROLLERS, OUTDOOR TOYS, ETC,. WHERE PARKED ITEMS WILL NOT OBSTRUCT CIRCULATION.

PROVIDE ONLY ONE MASTER SUITE. OTHER BEDROOMS SHOULD HAVE ACCESS TO A COMMON BATHROOM. IN THREE-BEDROOM UNITS PROVIDE AT LEAST TWO FULL BATHROOMS.

SEPERATE SLEEPING AREAS FROM LIVING AREAS.

PROVIDE EACH BEDROOM WITH ACCESS TO A FULL BATHROOM WITHOUT GOING THROUGH LIVING AREAS.

J-55 (B) PROVIDE A BATHTUB IN THE UNIT.

1ST LEVEL-UNIT 3 & 6

PROVIDE AT LEAST A HALF BATH ON THE FLOOR WITH THE LIVING ROOM, DINING AREA AND KITCHEN.

THE DINING AREA SHOULD HAVE ENOUGH ROOM FOR A DINING TABLE WITH ALL HOUSE HOLD MEMBERS SEATING AROUND IT PLUS CIRCULATION.

195(8) THE LIVING AREA SHOULD HAVE ENOUGH ROOM FOR SEATING ALL FAMILY MEMBERS PLUS OTHER FURNITURE AND CIRCULATION.

IN UNITS NEAR PLAY AREA, PROVIDE WINDOWS THAT ALLOW FOR SUPERVISION OF CHILDREN OUTDOORS.

HALLWAYS IN UNITS SHOULD BE WELL LIGHTED AND WIDE ENOUGH FOR CHILDREN TO PLAY IN.

PROVIDE SPACE THAT CAN CHANGE USE AS CHILDREN GROW, SUCH AS FROM TODDLER PLAY TO HOMEWORK TO MUSIC MAKING TO GATHERING.



WEST ELEVATION (N.T.S)



EAST ELEVATION (N.T.S)



5876 & 5880 DOYLE STERMINE CA 94608

No.	Description	Dat
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RENDERED ELEVATIONS WEST/ EAST

 Project number
 Project Number

 Date
 19TH SEPTEMBER 2017

 Drawn by
 Author

 Checked by
 Checker

A6.0



NORTH ELEVATION (N.T.S)



SOUTH ELEVATION (N.T.S)



5876 & 5880 DOYLE STERMILLE CA 94608

No.	Description	Dat

15

RENDERED ELEVATIONS SOUTH/NORTH

SOUTH/NORTH
Project number Project Number
Date 19TH SEPTEMBER 2017
Drawn by Author
Checked by Checker

A6.1



NORTH ELEVATION OF COMMON DRIVEWAY (N.T.S)



SOUTH ELEVATION OF COMMON DRIVEWAY (N.T.S)



5876 & 5880 DOYLE STEMERYVILLE CA 94608

No.	Description	Date

Sta

RENDERED COMMON DRIVEWAY

Project number Project Number

Date 19TH SEPTEMBER 2017

Drawn by Author

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ENTRY TO UNIT 1



5876 & 5880 DOYLE S EMERYVILLE CA 94608

No.	Description	Dat

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3D VIEW OF FRONT ENTRY

Project number	Project Nu
Date	19TH SEPTEMBER
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ENTRY TO UNIT 4



5876 & 5880 DOYLE S EMERYVILLE CA 94608

No.	Description	Date

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3D VIEW OF FRONT ENTRY

 Project number
 Project Number

 Date
 19TH SEPTEMBER 2017

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3D VIEW FROM DOYLE ST

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	Date	19TH SEPTEMBER 20
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	Checked by	Check

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No.	Description	
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3D VIEW OF COMMON ALLEY

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	Date	19TH SEPTEMBER 201	
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	Checked by	Checke	

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3D VIEW COMMON OPEN SPACE

Project number	Project Number
Date	19TH SEPTEMBER 201
Drawn by	Autho
Checked by	Checke

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