# DOYLE STREET MEWS



	SHEE	T INDE	X
	Architectural S	heet List	
A000 A002	Cover Sheet Unit desc & area tabulation	A301 A401 A402	
A101 A101a	Site Plan Existing / Demolition Plan	Ex 1 Ex 2 Ex 3	Elevation Renderings Context Renderings Family-Friendly Desig
A201 A202 A203	1st Story Floor Plan 2nd Story Floor Plan 3rd Story Floor Plan	L-1 L-2	Landscape Plan Landscape Add'l Detai

Surveyor Sheet List

Sheet 1 Topographical Land Survey

#### PROJECT DATA

Site Address 5876 Doyle Street, Emeryville, Ca.

Site Address 5880 Doyle Street, Emeryville, Ca. Lot/Parcel Area (Calculated) 10,000 (sq ft) 0.230 AC. Assessor Parcel No. (APN) 49-1330-12 & 13

#### **PARKING TABULATION**

**PARKING TABULATION:** (1) COVERED STALL INSIDE GARAGE/UNIT = 4 STALLS

(1) OPEN STALL/UNIT = 2 STALLS TOTAL PARKING PROVIDED = 6 STALLS

**BIKE PARKING TABULATION:** COVERED BIKE RACK = 2 SPACES INTERIOR GARAGE AREAS = 4 SPACES

5876-5880 Doyle Street, Berkeley Bowl West = Emeryville Project location 63rd St & 62nd St 61 st St Emeryville

**VICINITY MAP** 

**Proposed demolition of residences** 

To allow for the construction of new residential buildings on our development site, we are proposing to demolish a single family house at 5880 Doyle Street and a 3-unit apartment building at 5876 Doyle Street.

#### **Proposed new residential structures**

The proposed project at 5876 - 5880 Doyle Street is made up of six family-friendly, condominium residences. All six condominiums will be for sale. Four of the residences will be 3-bedroom and two of the residences will be 2-bedroom. One parking space is provided per residence. Transportation needs will also be met by 12 resident (and 6 guest) covered bike parking spots, nearby public transit stops, Zipcar vehicles one block away, walking, casual carpooling into San Francisco and online car-service apps like Uber and Lyft. This project provides brand new, family-size housing in central, walkable Emeryville, which is a housing type that is in high demand in the area.

#### **Architectural Materials and Colors**

The building's materials and accents add character to the community while complying with the city's vision for urban architecture. The building will add to the community's vibrancy, incorporating natural elements into the streetscape. The structure itself adds visual interest to the neighborhood by incorporating floor step-backs, pop-outs and visual permeability. The Doyle Street Mews present beautiful horizontal hardwood siding at the first floor of the building. Above smooth troweled stucco that completes the plinth level, cement board siding and wood laminate siding interlock across the second and third floor facades. Aluminum or stainless steel balustrades/railing supporting glass infill panels accent the decks.

#### Family-Friendly Design

All six residences in the project will conform to Emeryville's family-friendly design guidelines. Among other family-friendly design design elements, the residences will have: a minimum of two bedrooms (most will have three bedrooms), in-unit laundry hook-ups, sleeping areas that are separated from living areas, a half bathroom on the floor with the living/dining rooms and kitchen, a dining area that has enough room for a family-sized dining table with all household members seated around it (plus circulation), and infant and toddler safety features. Family-friendly design will generate 50 community benefit bonus points for the project.

#### **Support of Small, Local-Serving Businesses**

The developer will make a contribution to the Citywide fund to support small, local-serving businesses. This contribution will equate to 5% of the project's construction valuation, and will generate 50 community-benefit bonus points.

#### **Emeryville Design Guidelines conformity**

The two proposed buildings and site plan conform to the City's general design guidelines. For example, sidewalks are sufficiently wide, parking is hidden from view from the street, refuse bins are shielded from view, street wall façades create visual interest and are three-dimensional in nature, building windows and doors provide eyes on the street, buildings will incorporate sustainable design features and high-quality and durable architectural materials and finishes, and open space will be provided at or above minimum requirements.

#### North Hollis Area Urban Design conformity

The project will incorporate a well-lit building frontage that promotes security, front entries to the residences along Doyle Street, front stoops and porches that connect to the public sidewalk, rear gardens or patios that are private in nature, and a ground floor elevation that will be within five feet of the grade of the public sidewalk.



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> 408.394.9281 LANDSCAPE ARCHITECT **INSIDE OUT** 6000 Harwood Avenue Oakland CA 94618 415.238.6251

### DOYLE STREET **MEWS**

5876 & 5880 DOYLE ST. EMERYVILLE, CA 94608

#### **COVER SHEET**

ISSUE	DESCRIPTION	DATE

**DATE:** JOB NO.

DRAWN

A000

**SHEET** 

UNIT AREA SCHEDULE				
UNIT TYPE	DESCRIPTION	COUNT	AREA (GROSS)	
PLAN A	3-BR/2.5 BA + BONUS	2	1,716 SQ. FT.	
PLAN B	3-BR/2.5 BA + BONUS	2	1,778 SQ. FT.	
PLAN C	3-BR/3.5 BA	2	1,477 SQ. FT.	
	TOTAL	6	9,942 SQ. FT.	

OPEN SPACE AREA SCHEDULE			
UNIT TYPE	COUNT	AREA	
COMMON OPEN SPACE	1	1,144 SQ. FT.	
PLAN A	2	493 SQ. FT.	
PLAN B	2	490 SQ. FT.	
PLAN C	2	870 SQ. FT.	
	TOTAL	4,850 SQ. FT.	



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# DOYLE STREET MEWS

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# UNIT DESCRIPTIONS AND AREA TABULATIONS

ISSUE	DESCRIPTION	DATI


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## DOYLE STREET **MEWS**


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### SITE PLAN

ISSUE	DESCRIPTION	DATE

JOB NO. DRAWN

A101 SHEET NO.

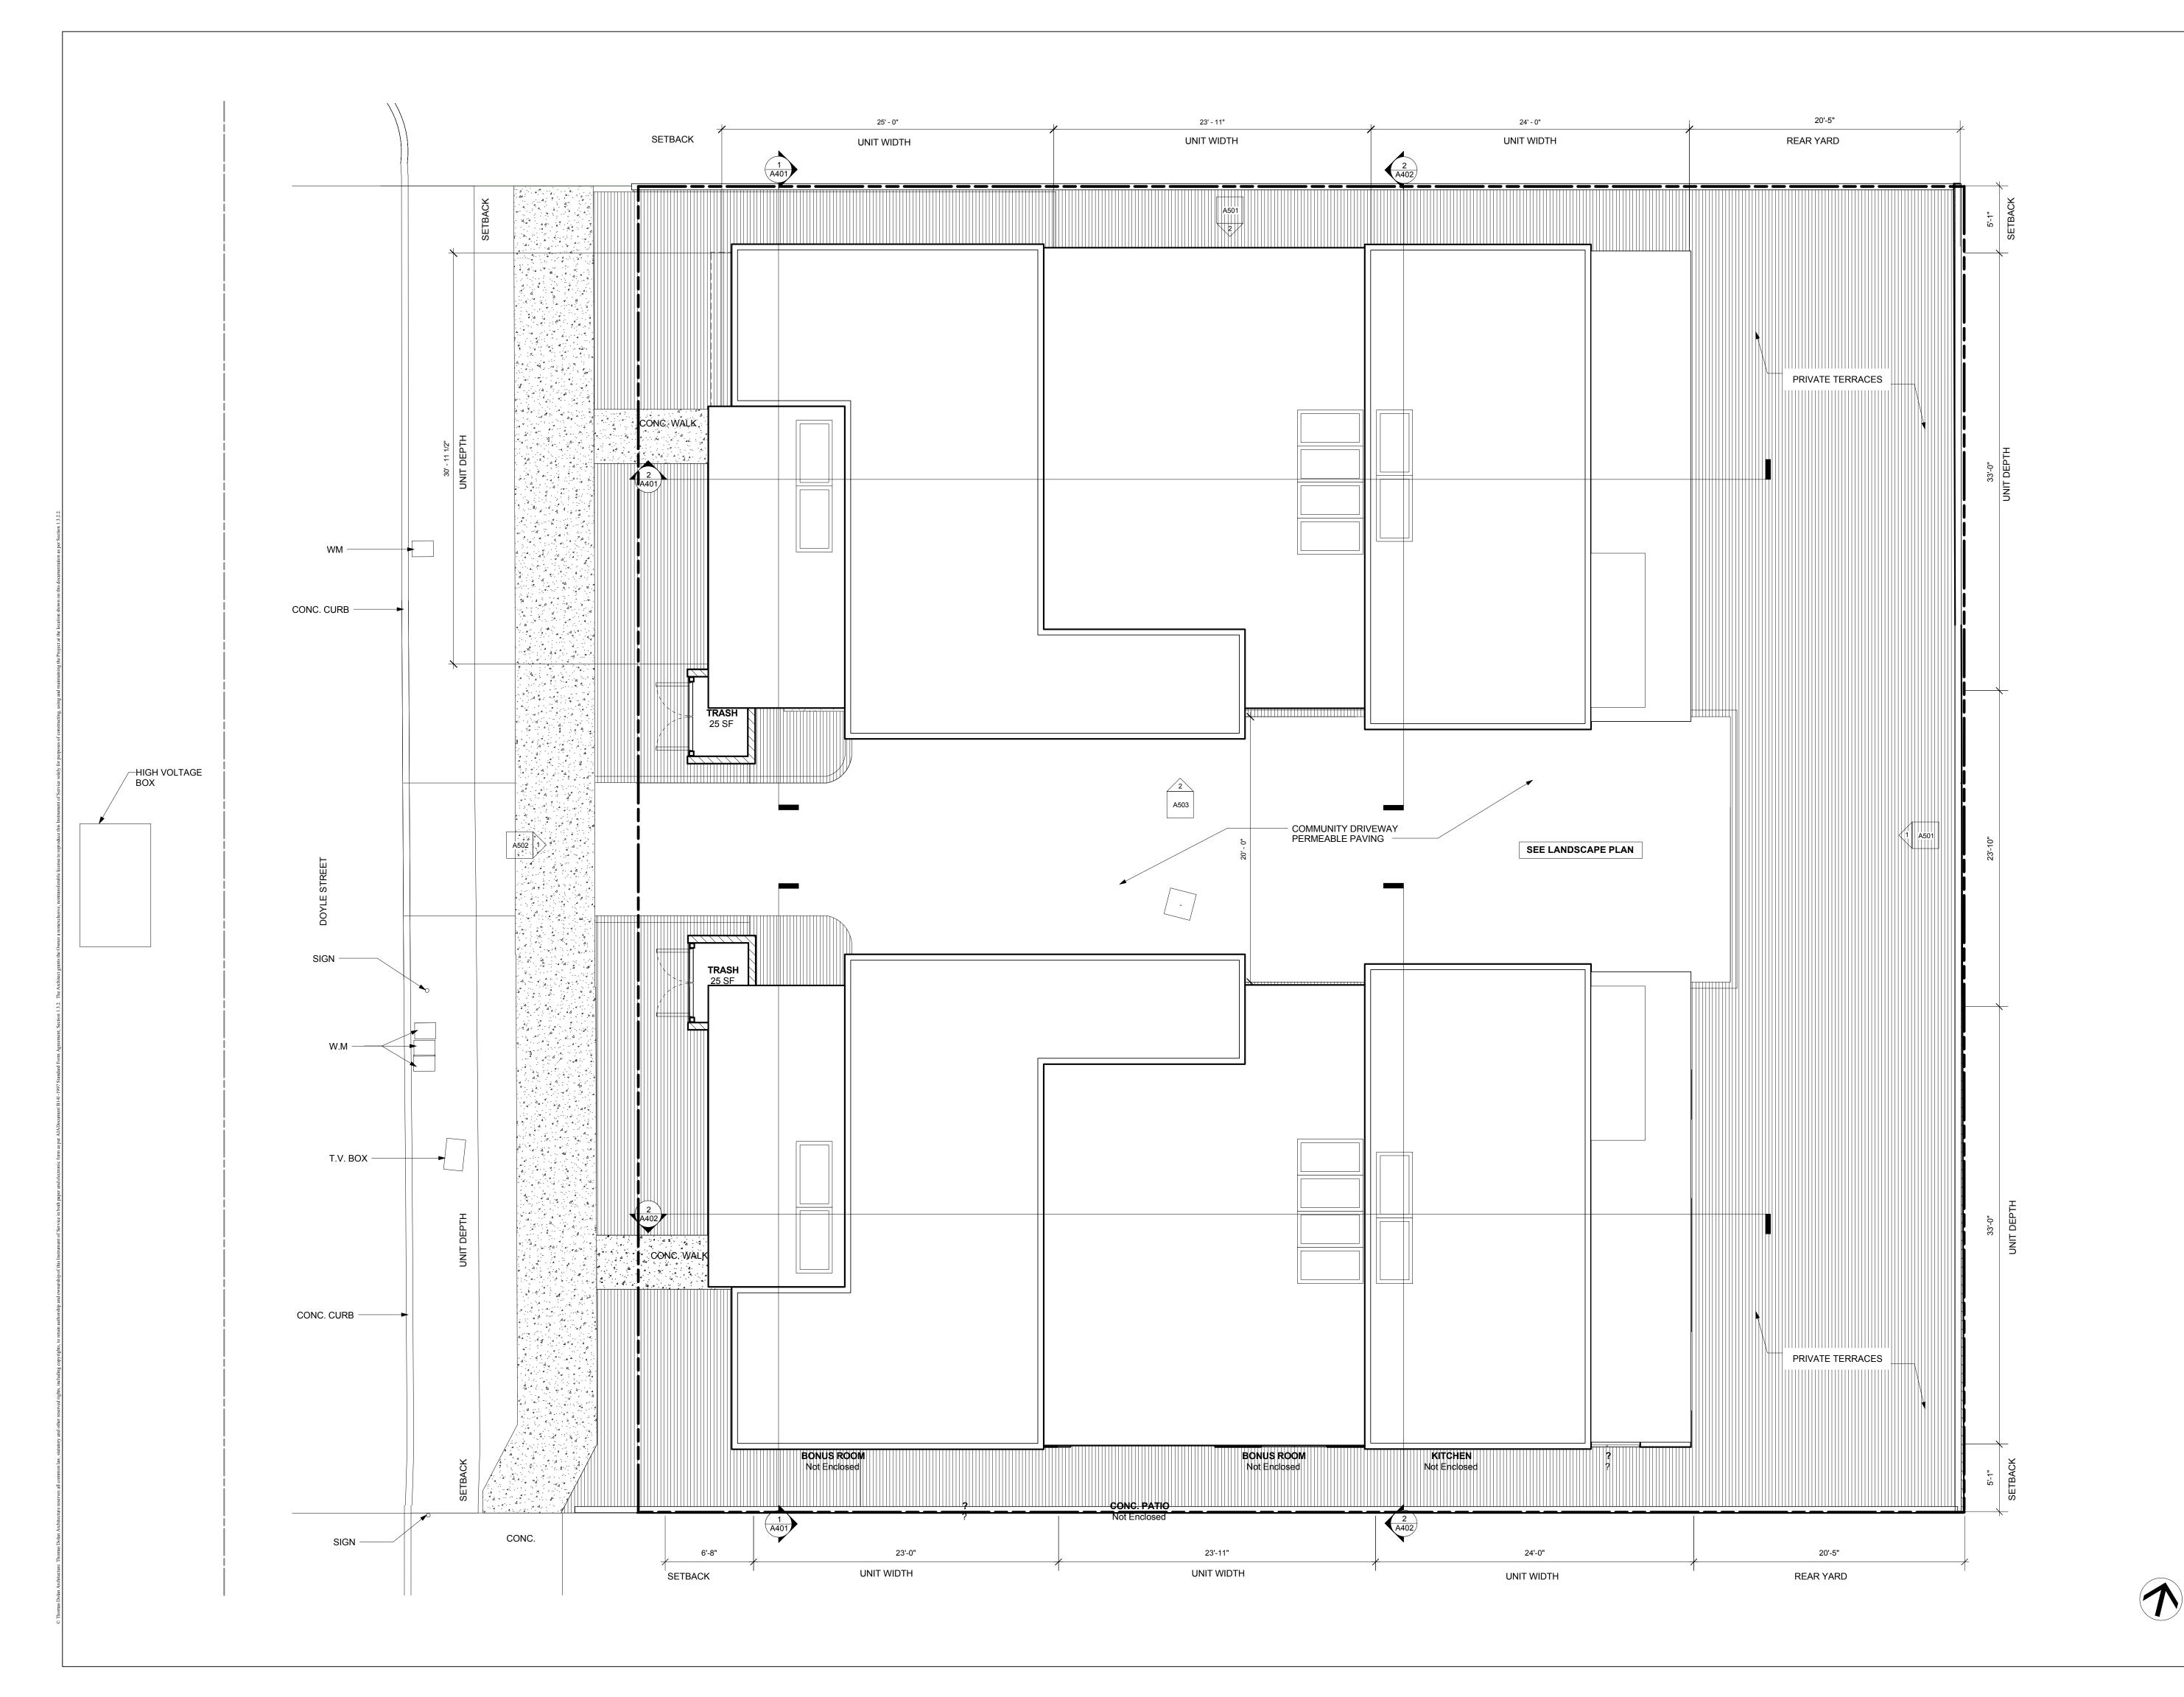

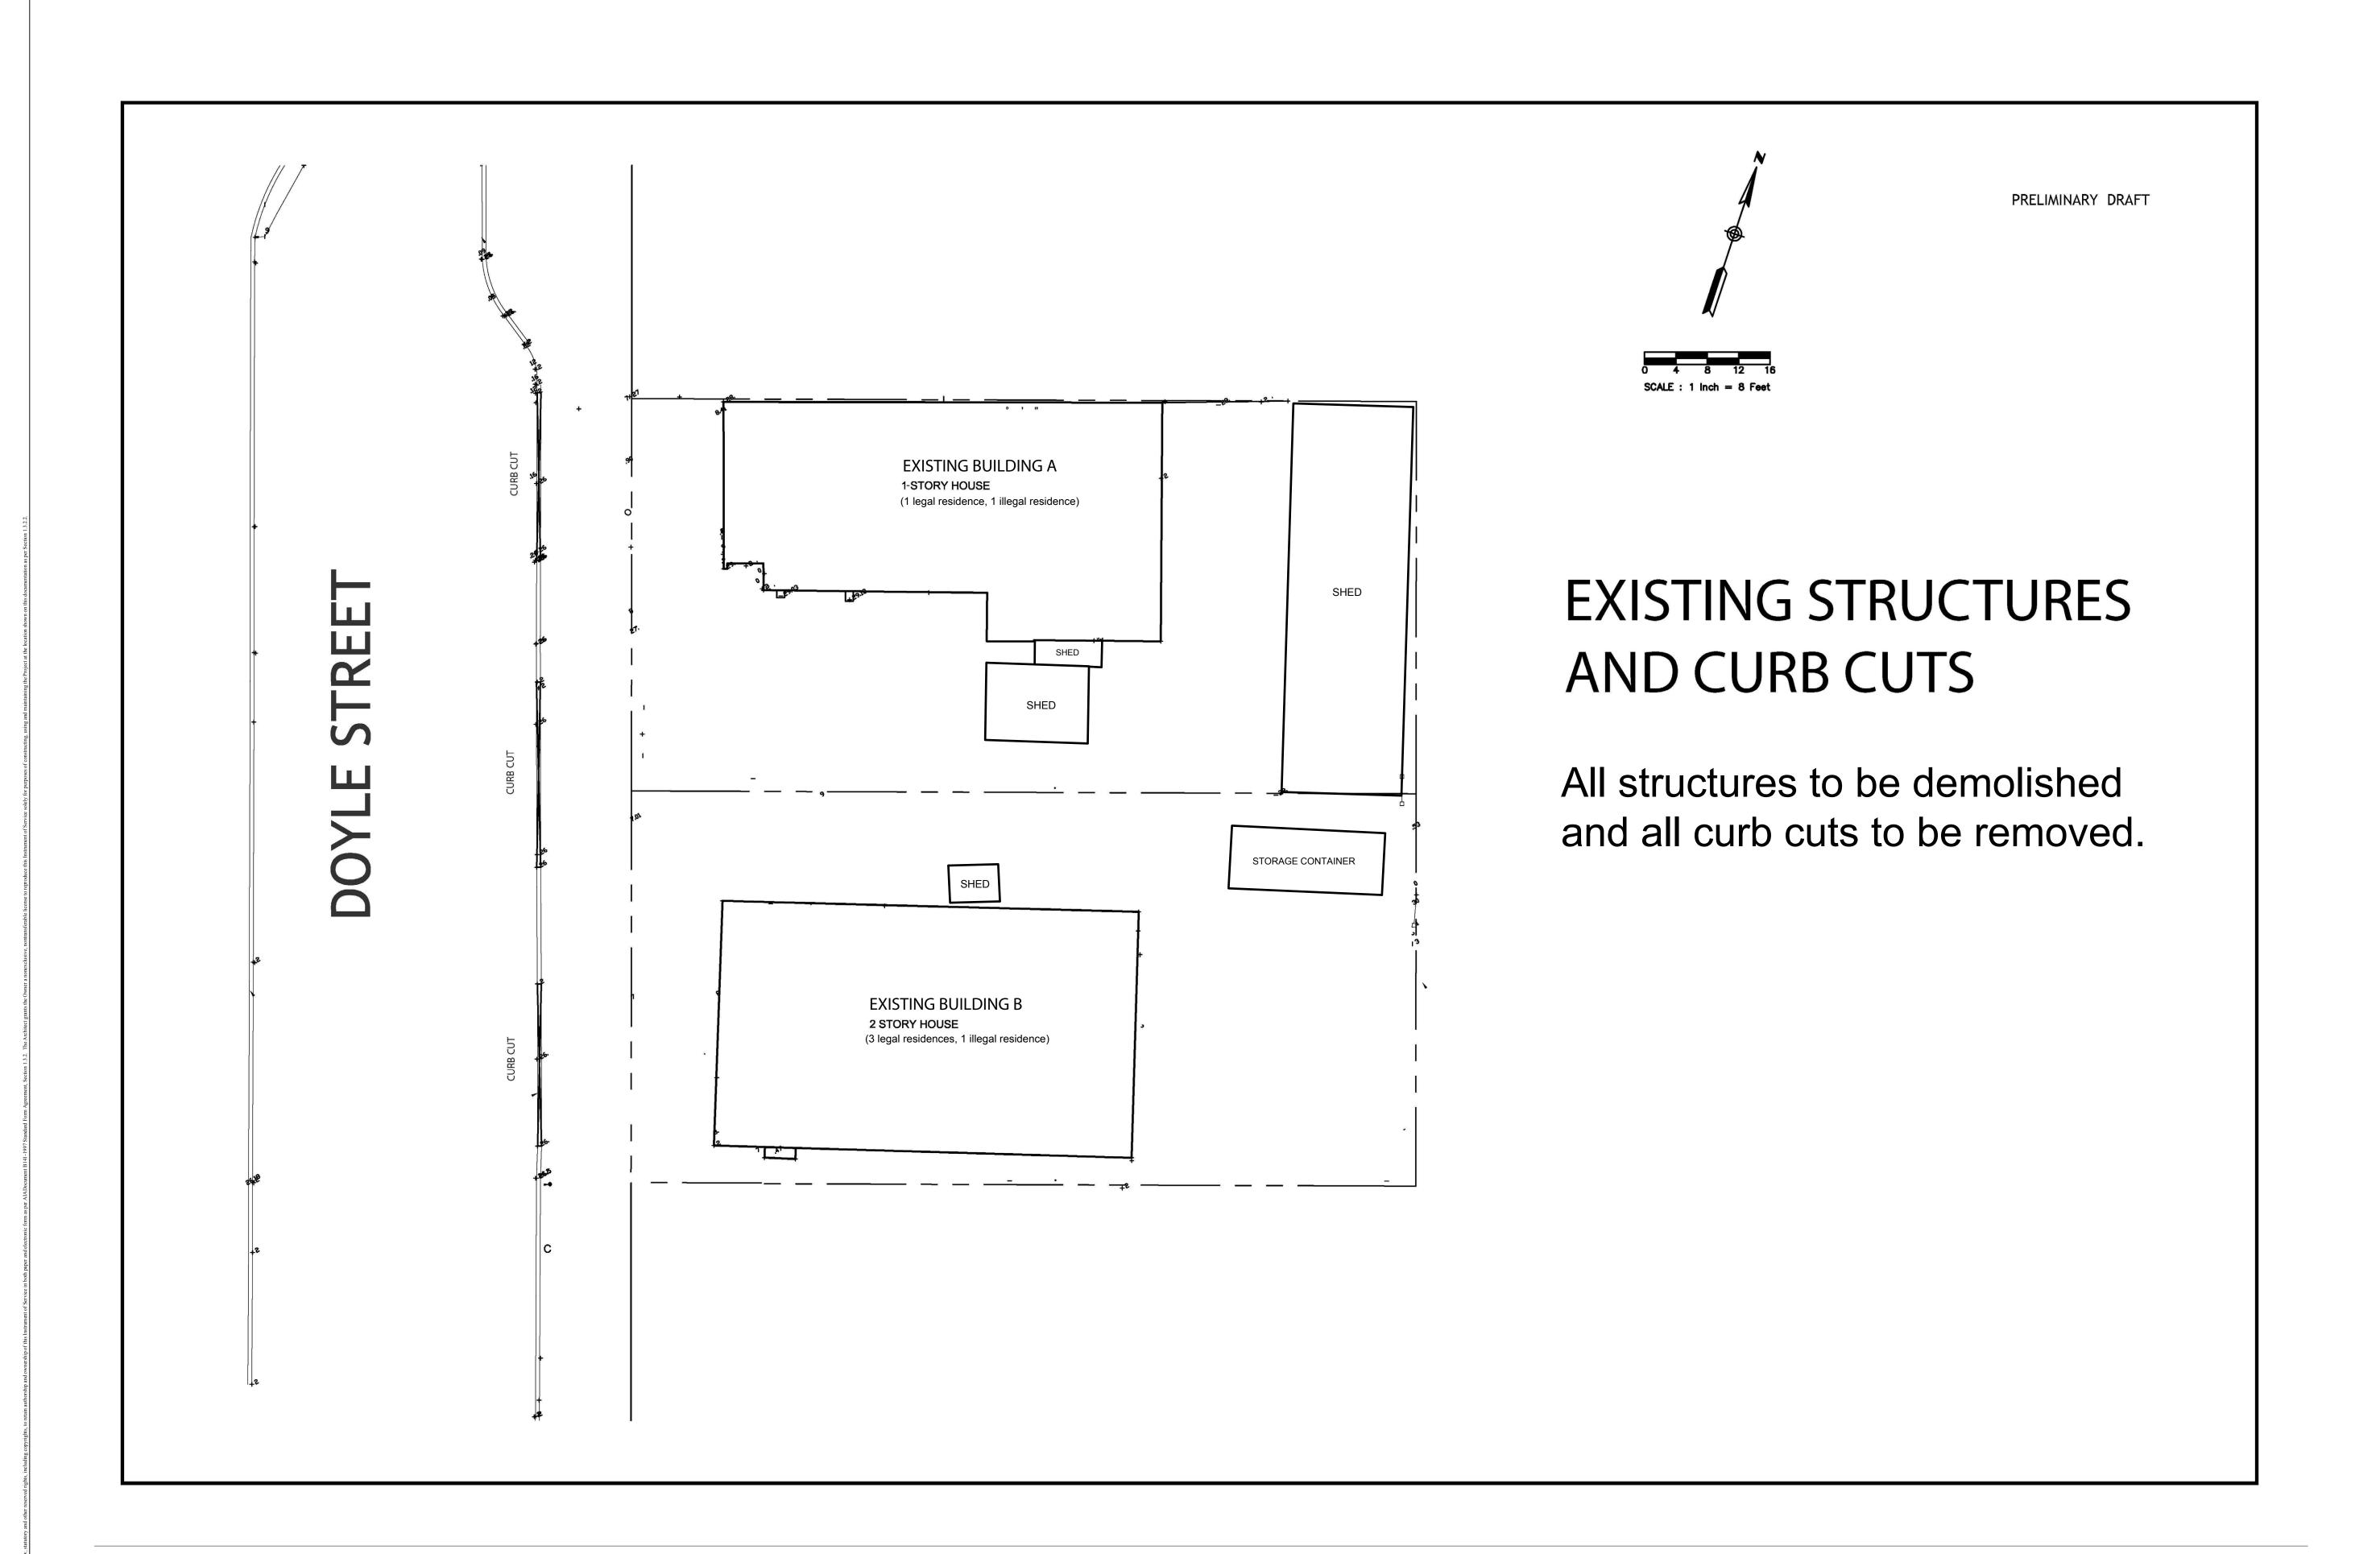



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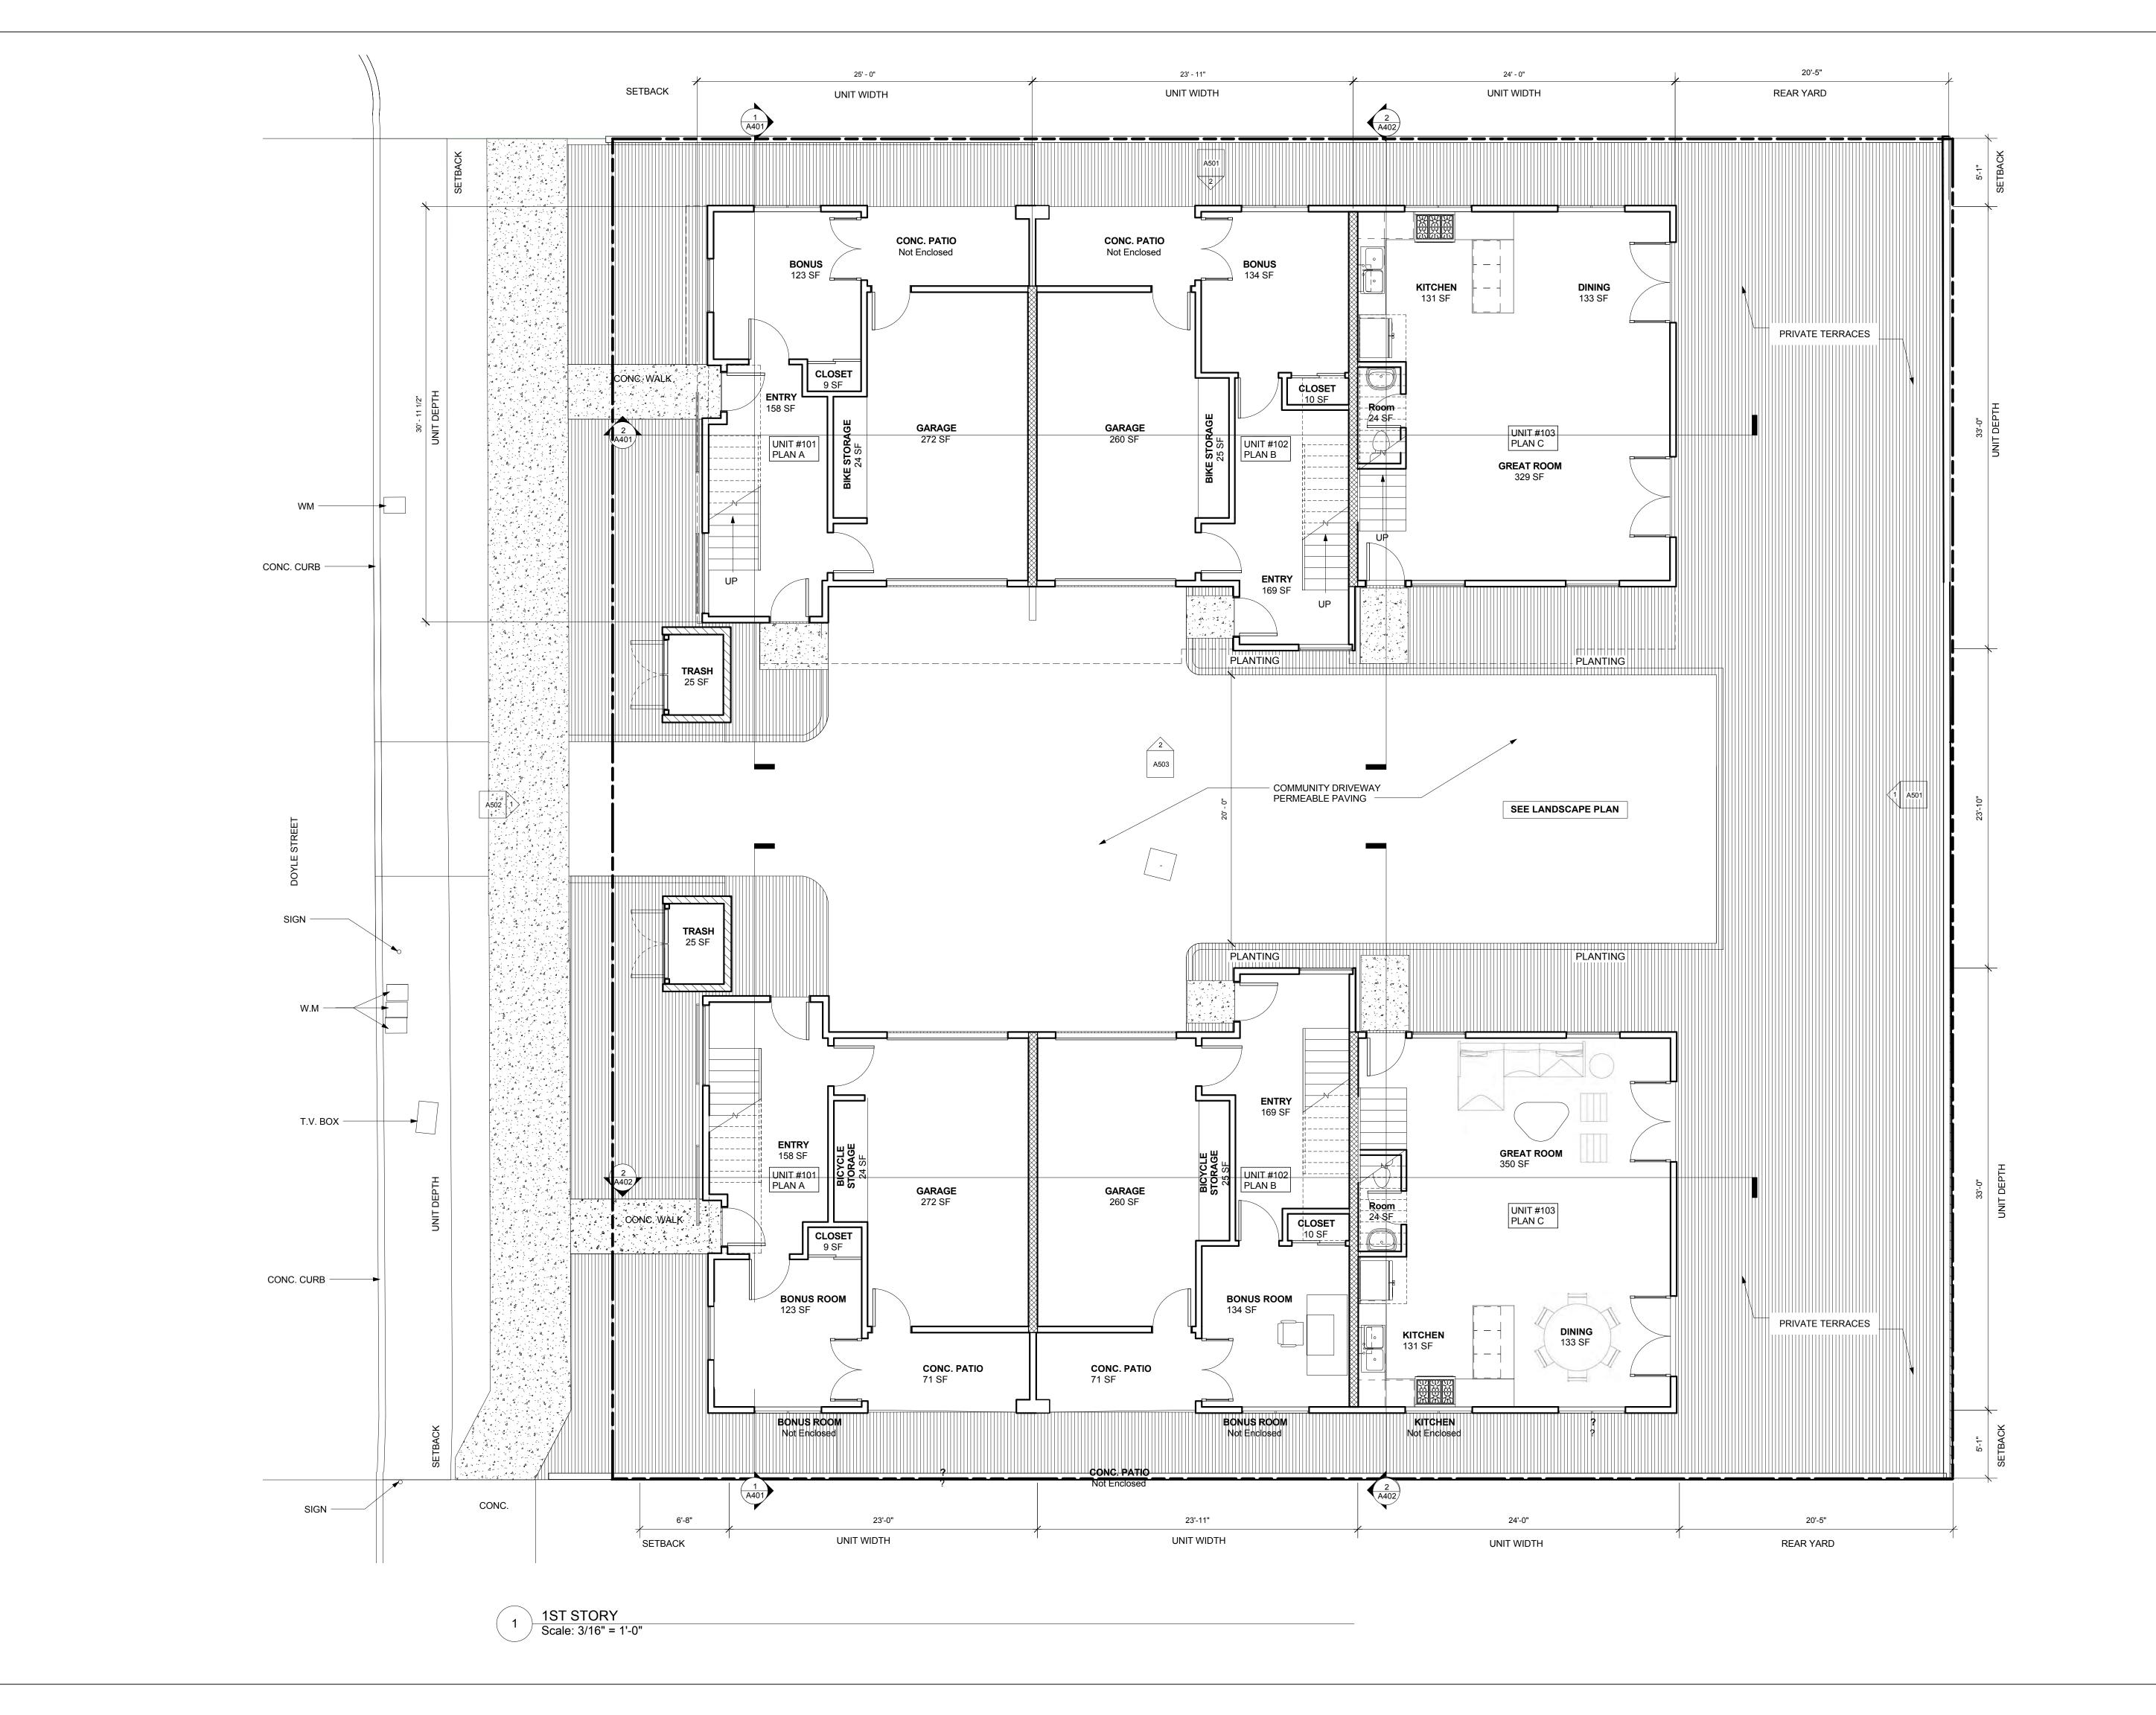
# EXISTING DEMOLITION PLAN

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### DOYLE STREET **MEWS**


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### 1ST STORY FLOOR PLAN

ISSUE	DESCRIPTION	DATE

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A201 SHEET



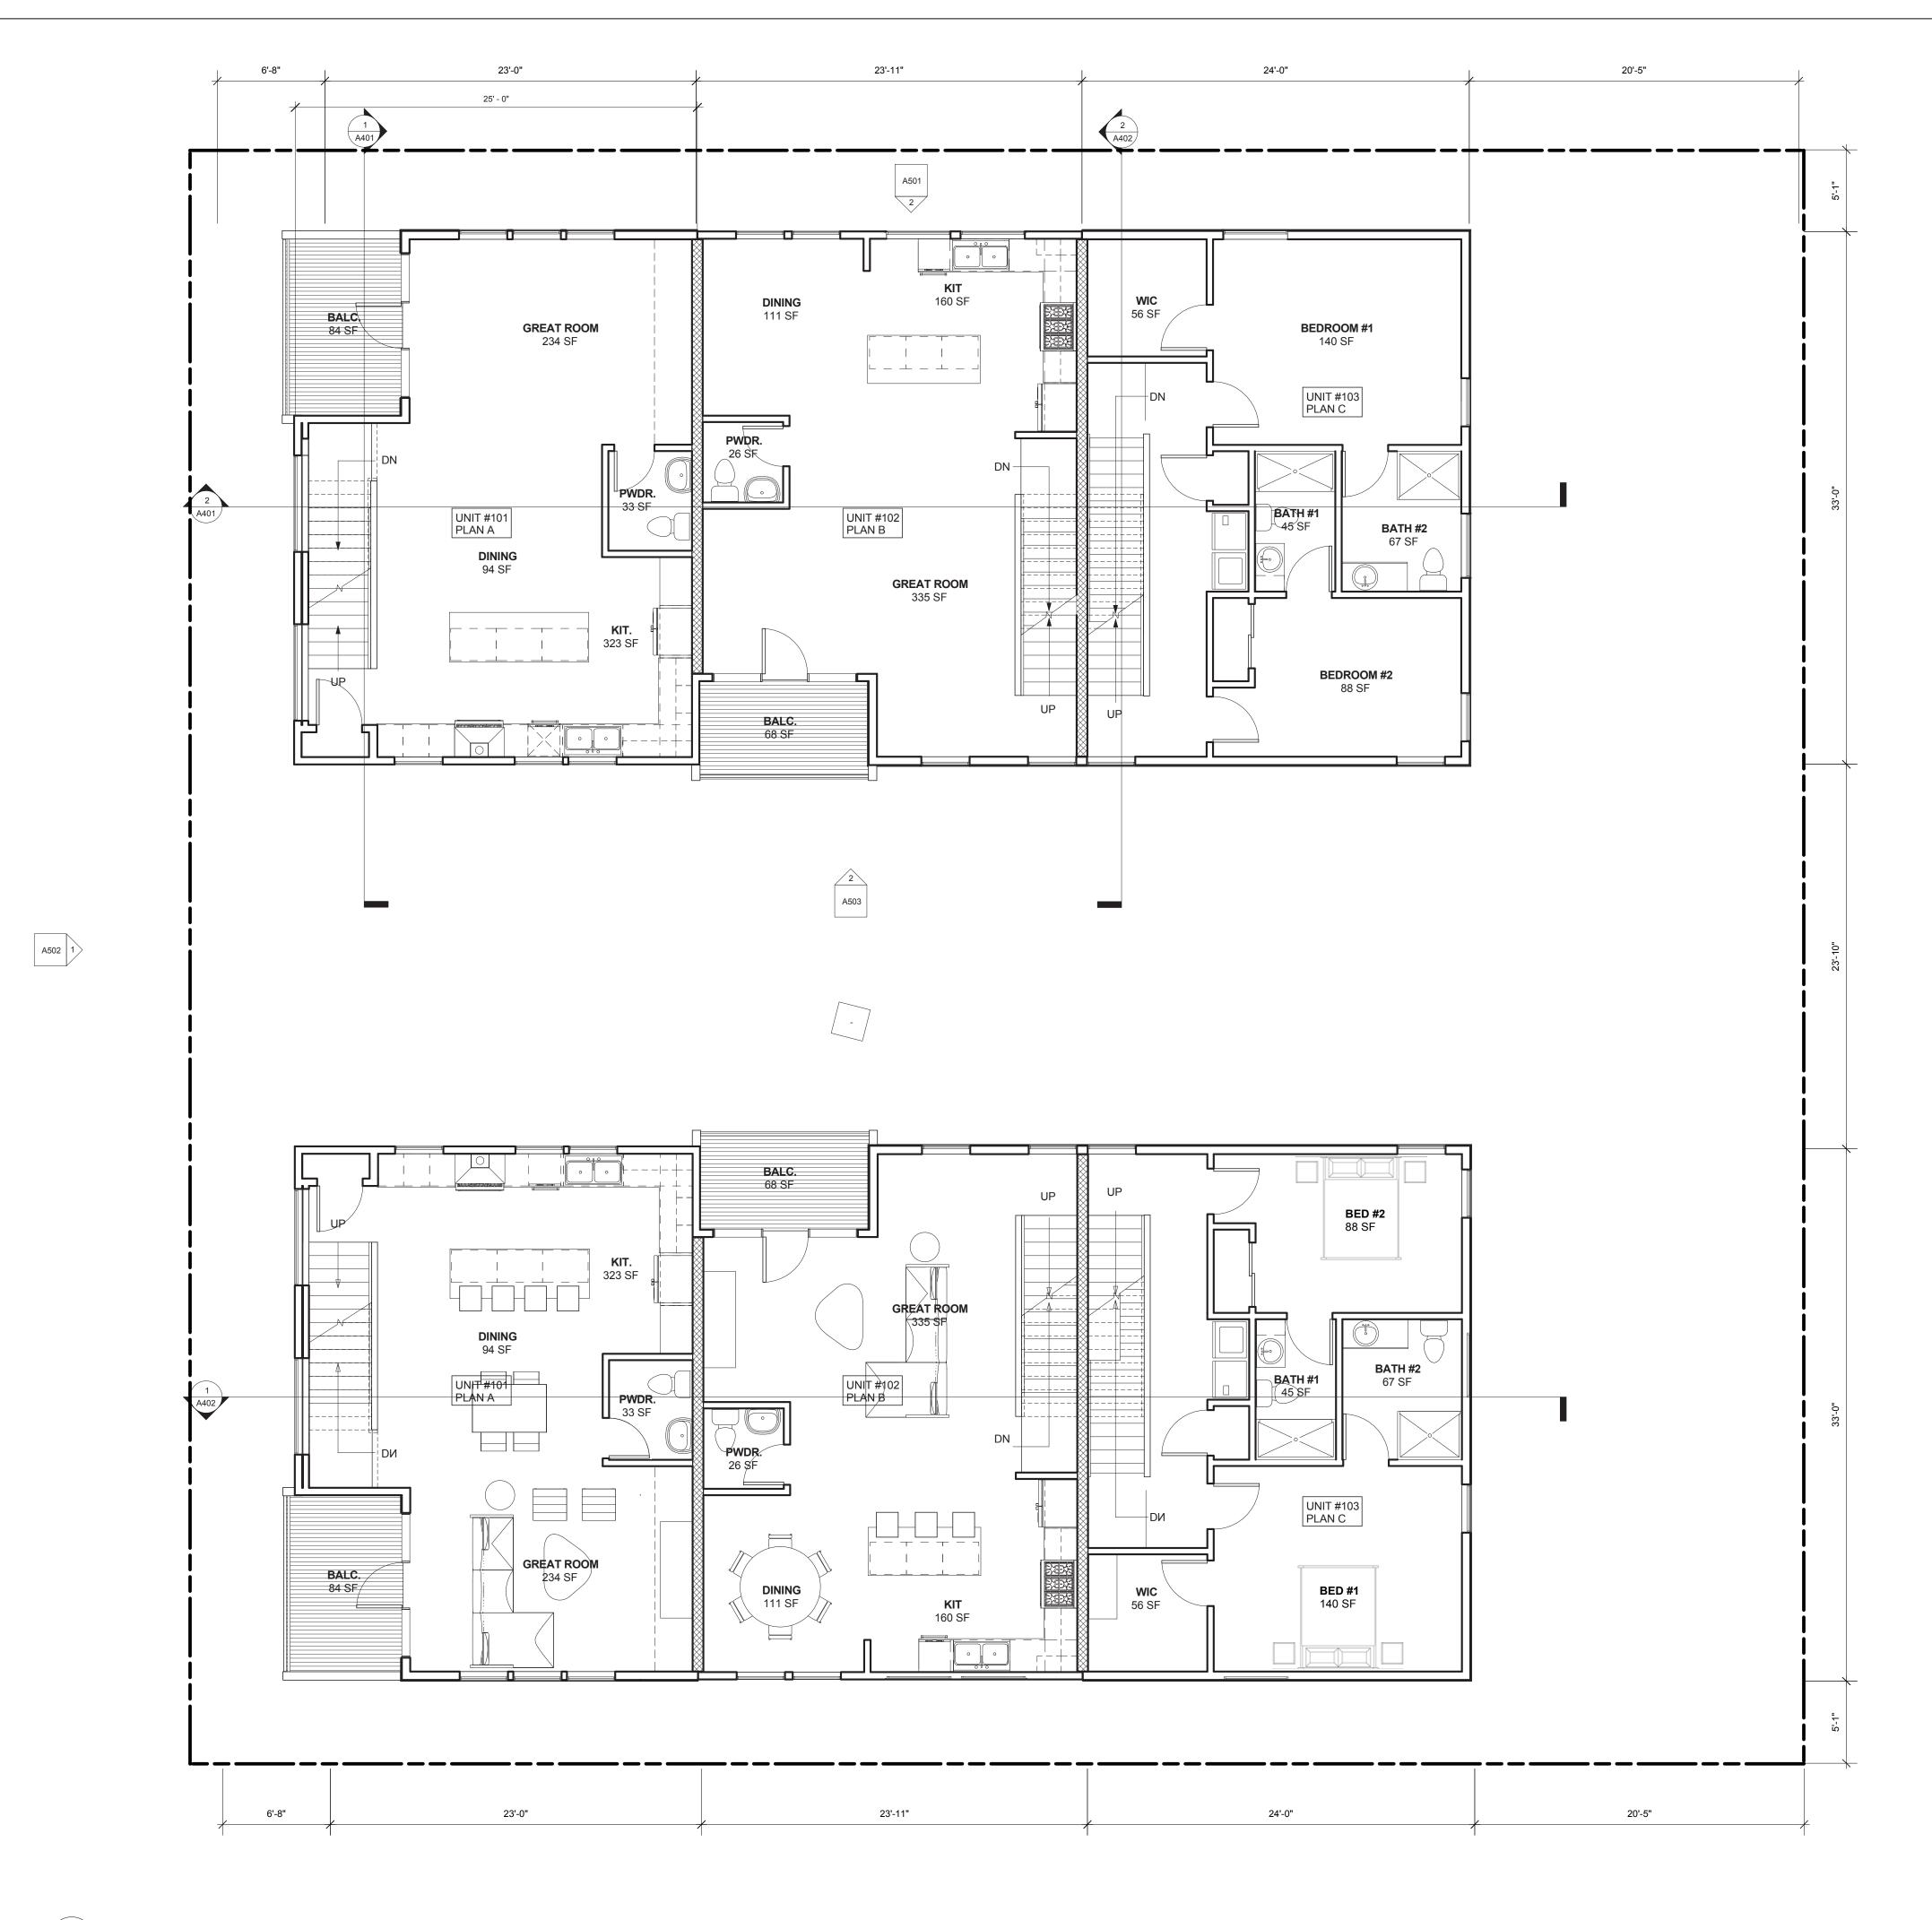

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## 2ND STORY FLOOR PLAN

ISSUE	DESCRIPTION	DATE
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DATE:
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1 2ND STORY Scale: 3/16" = 1'-0"





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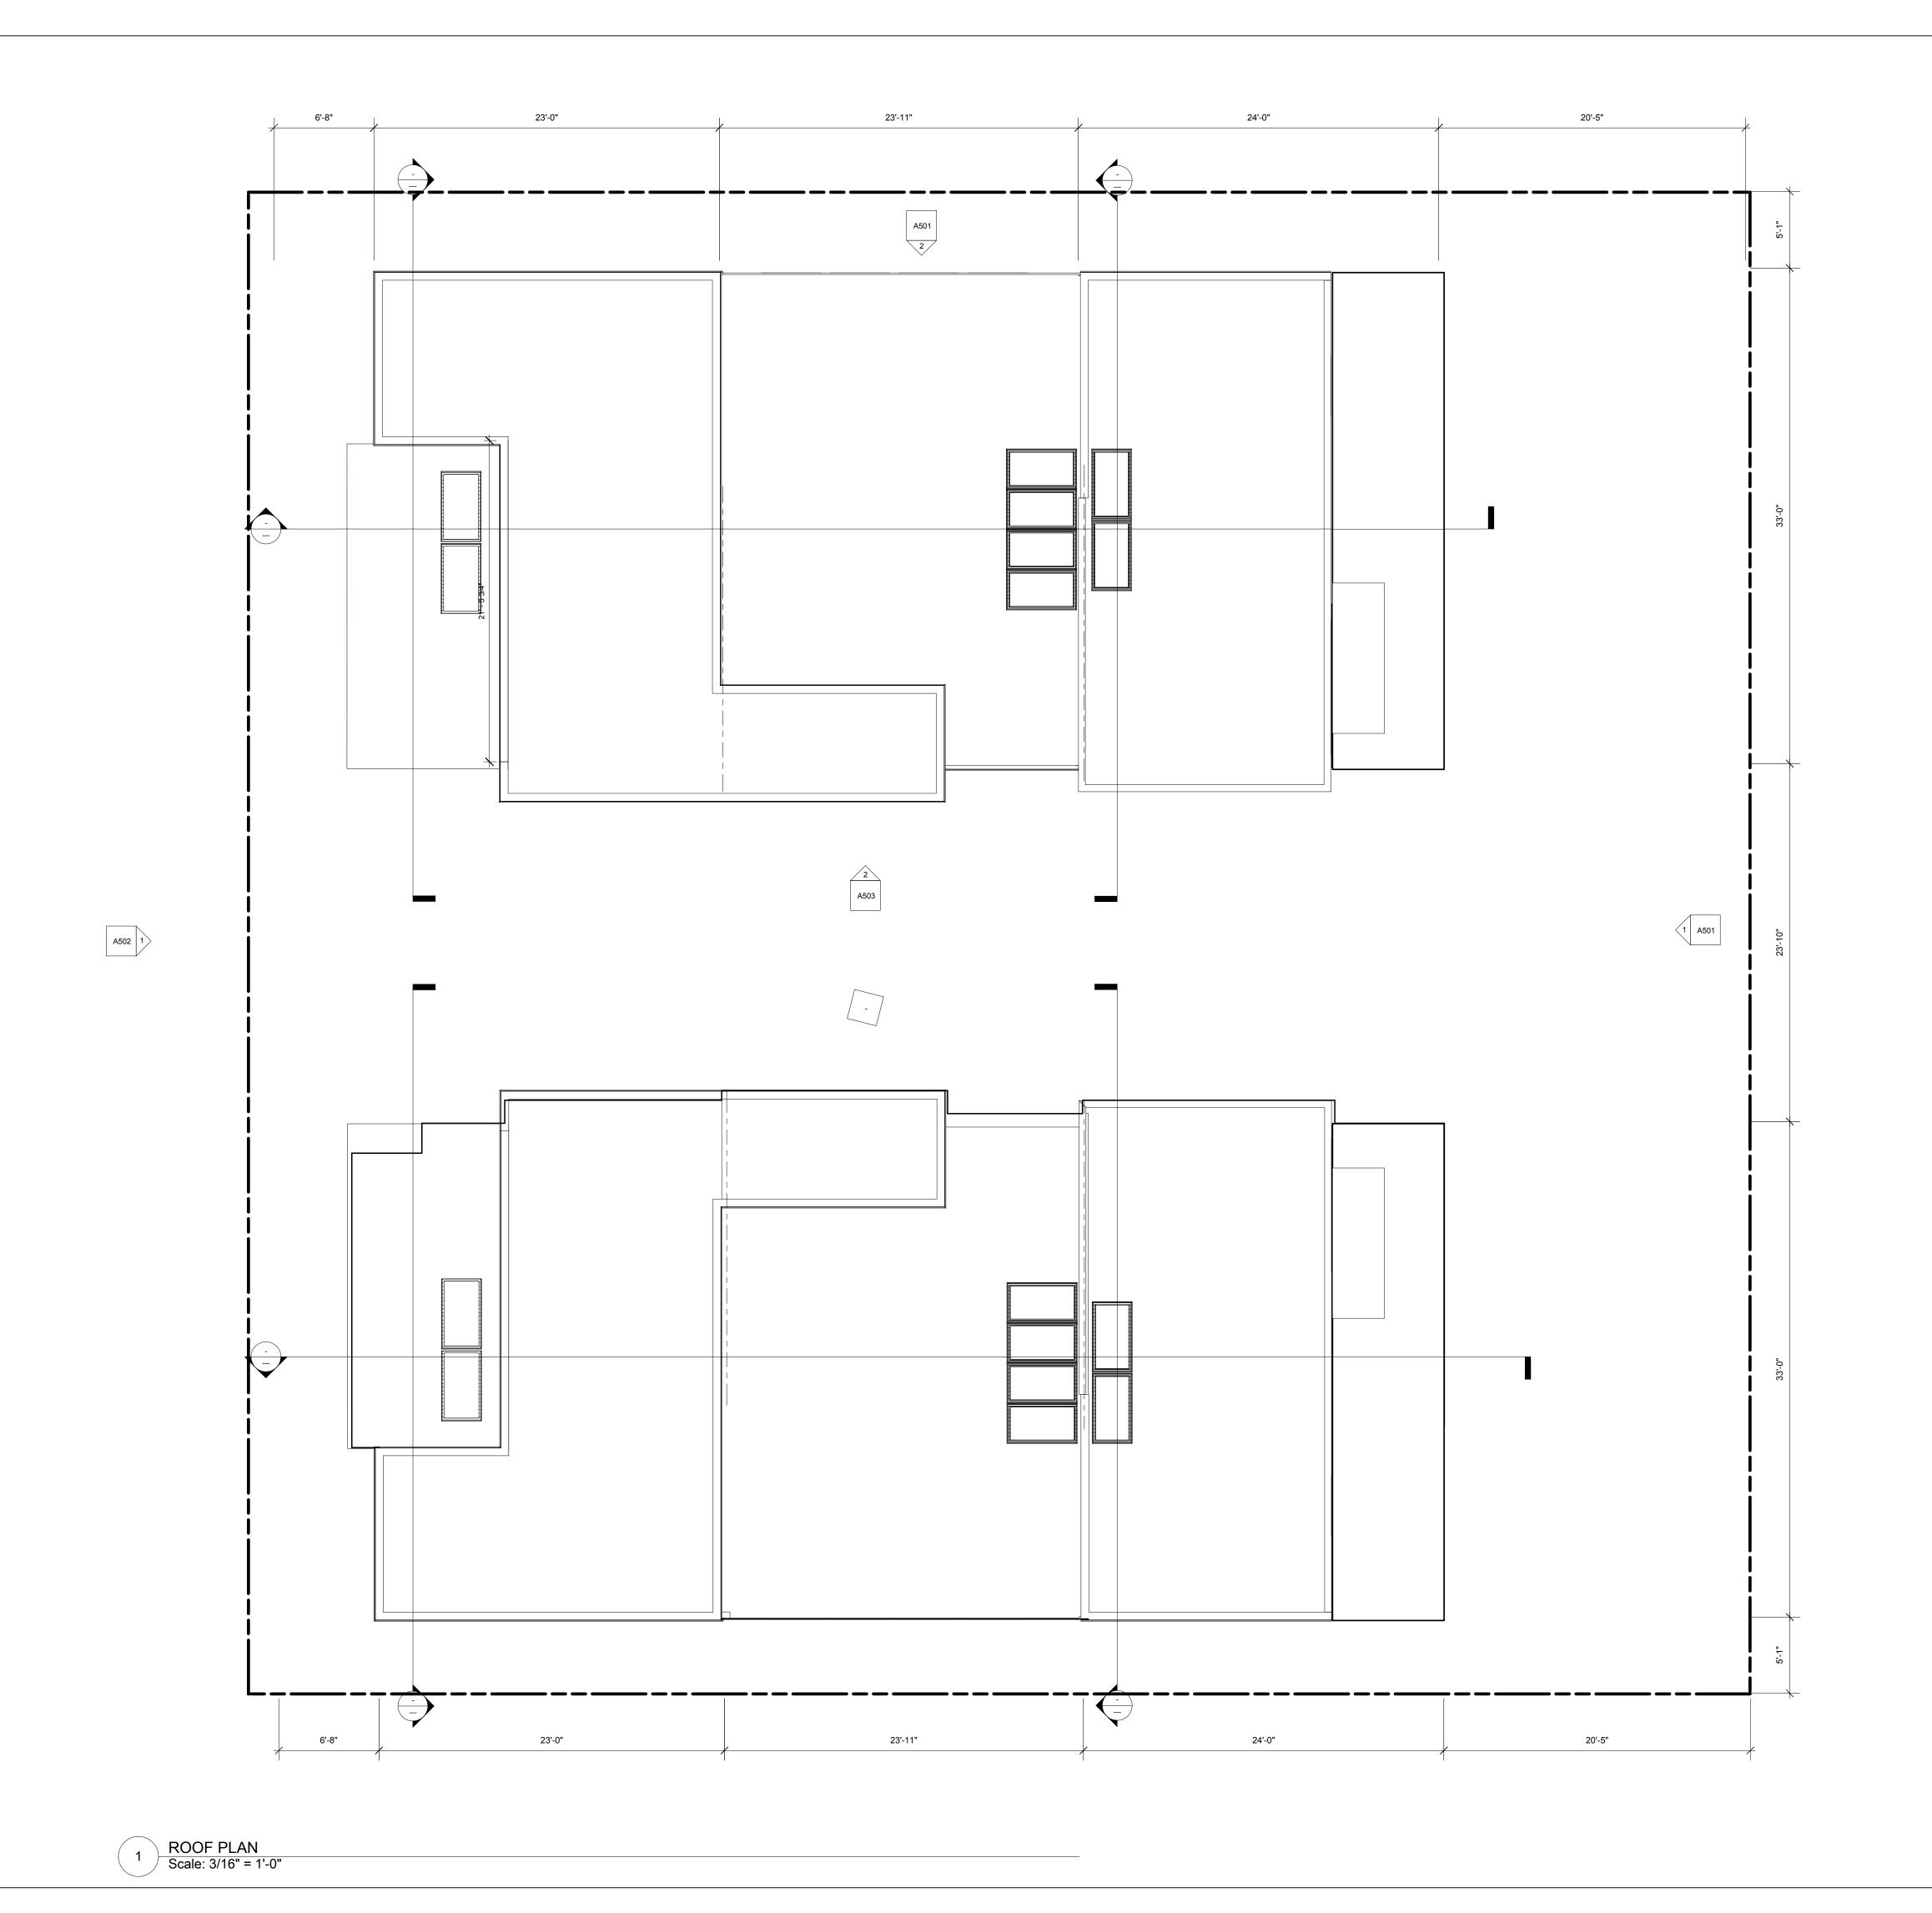
## 3RD STORY FLOOR PLAN

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### **ROOF PLAN**


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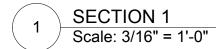
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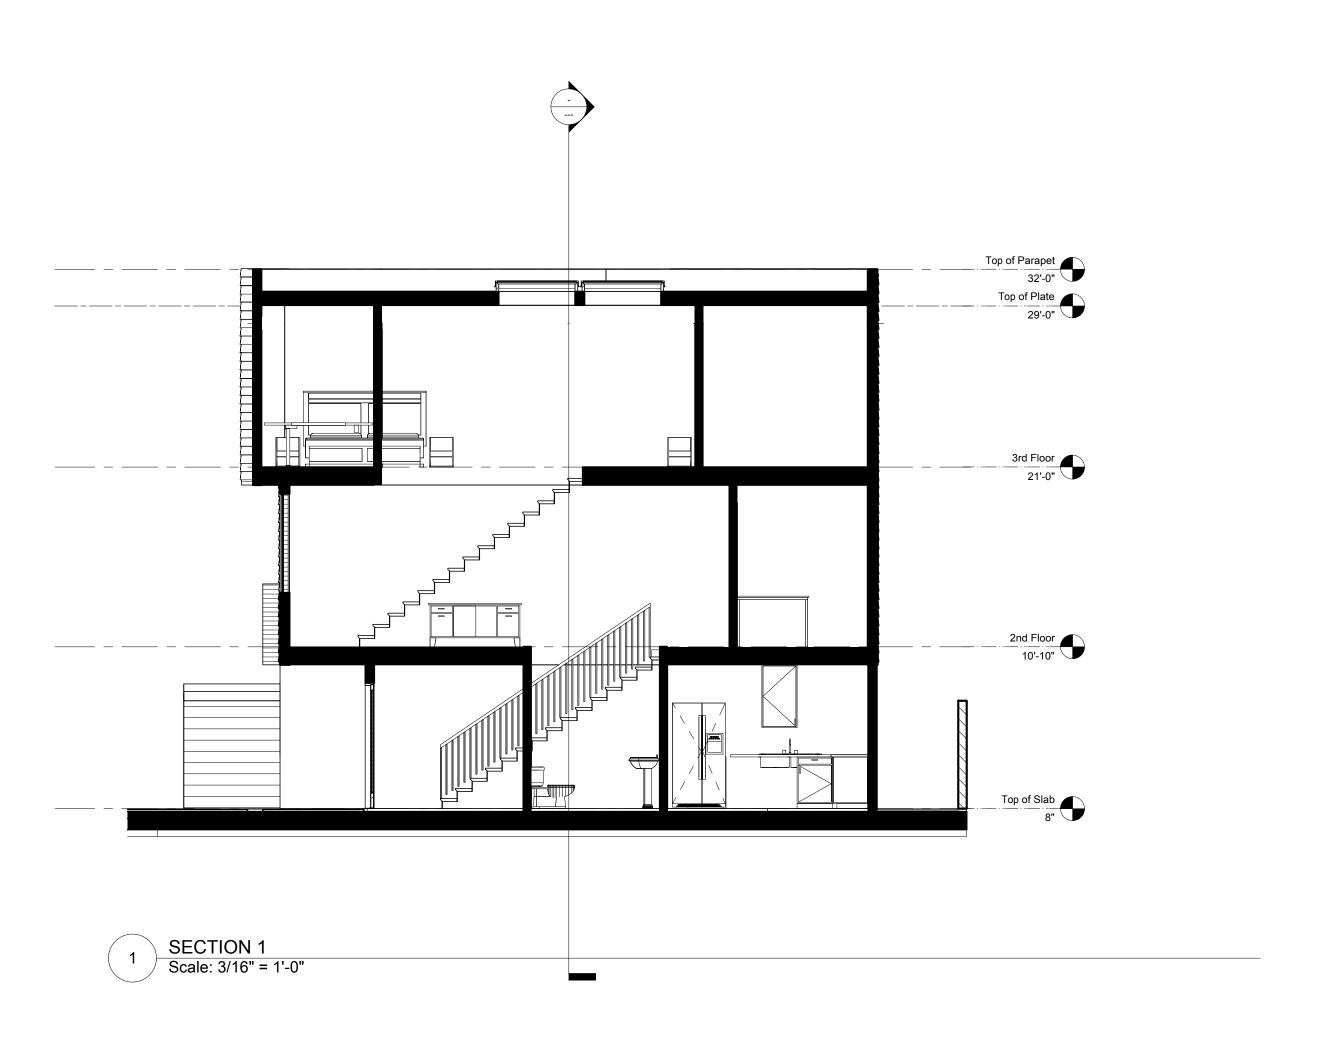
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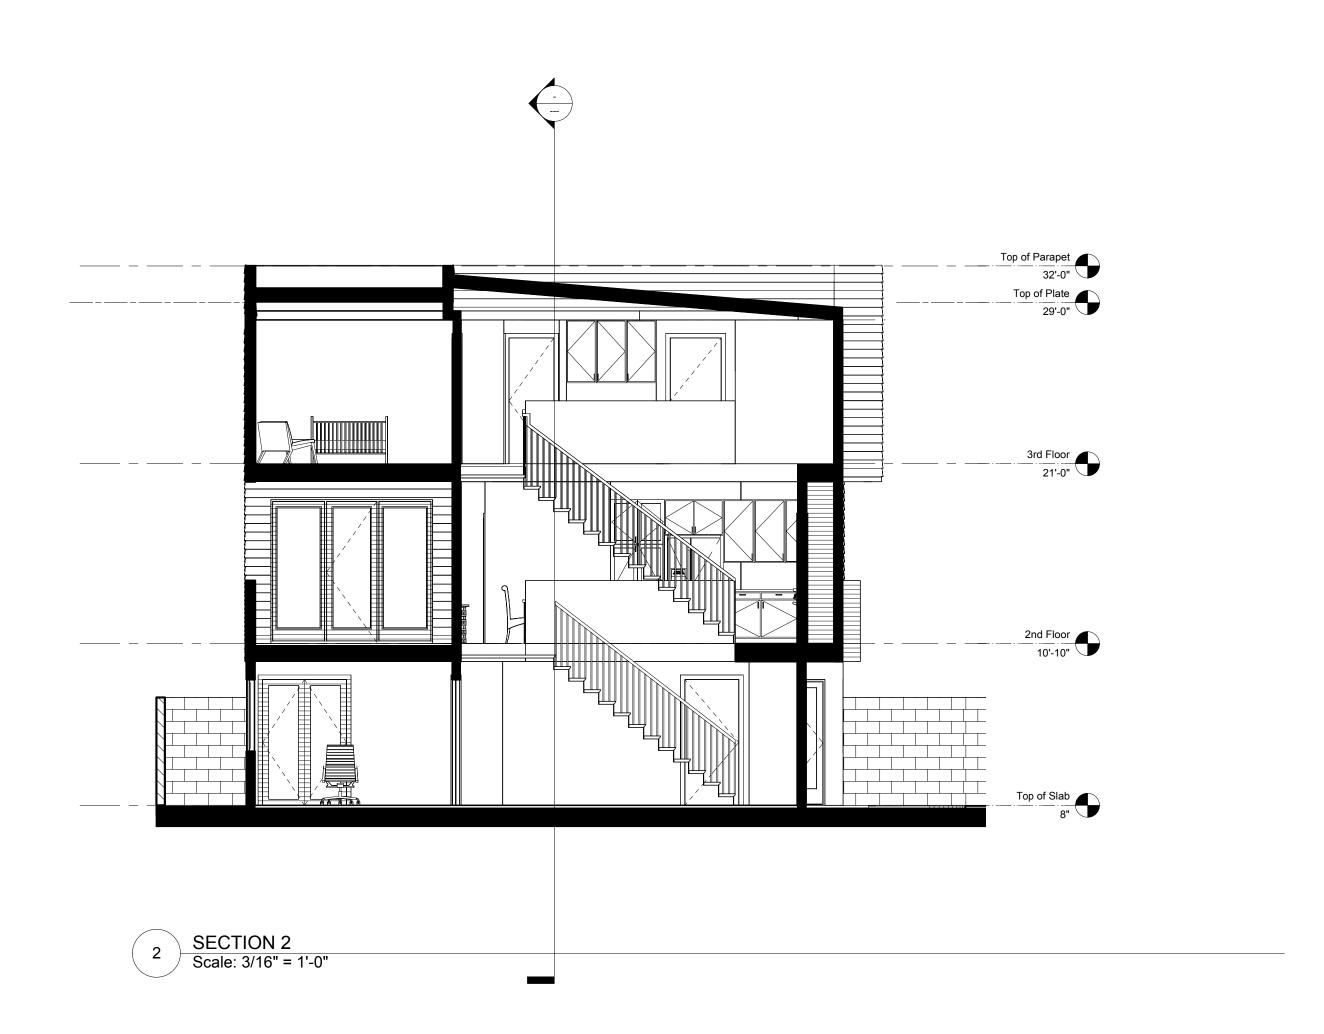
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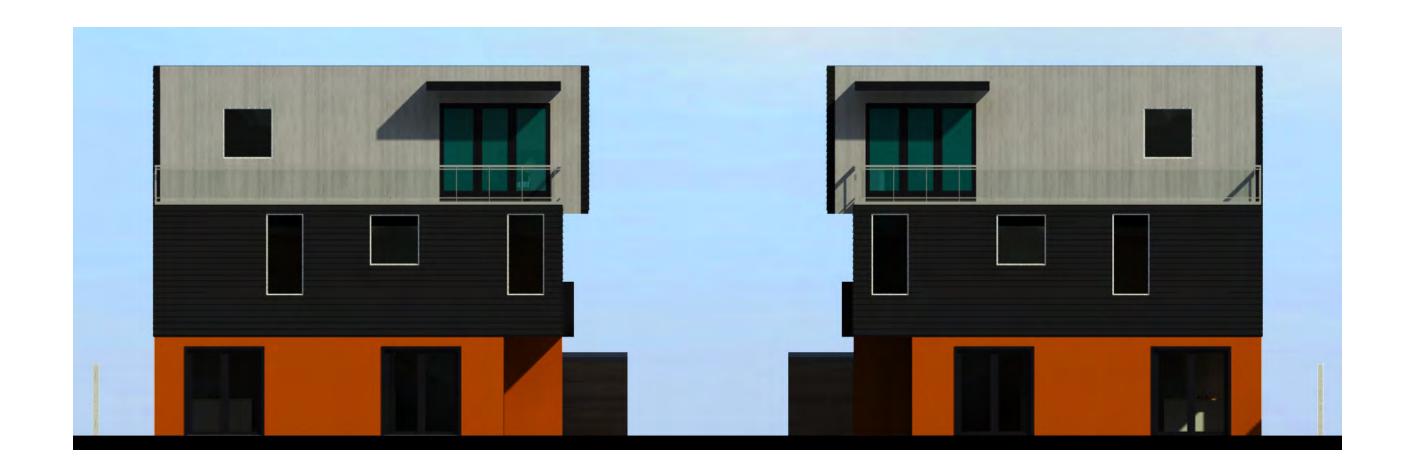
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### SECTIONS

ISSUE	DESCRIPTION	DATE

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HARDWOOD SIDING-

WEST (FRONT) ELEVATION

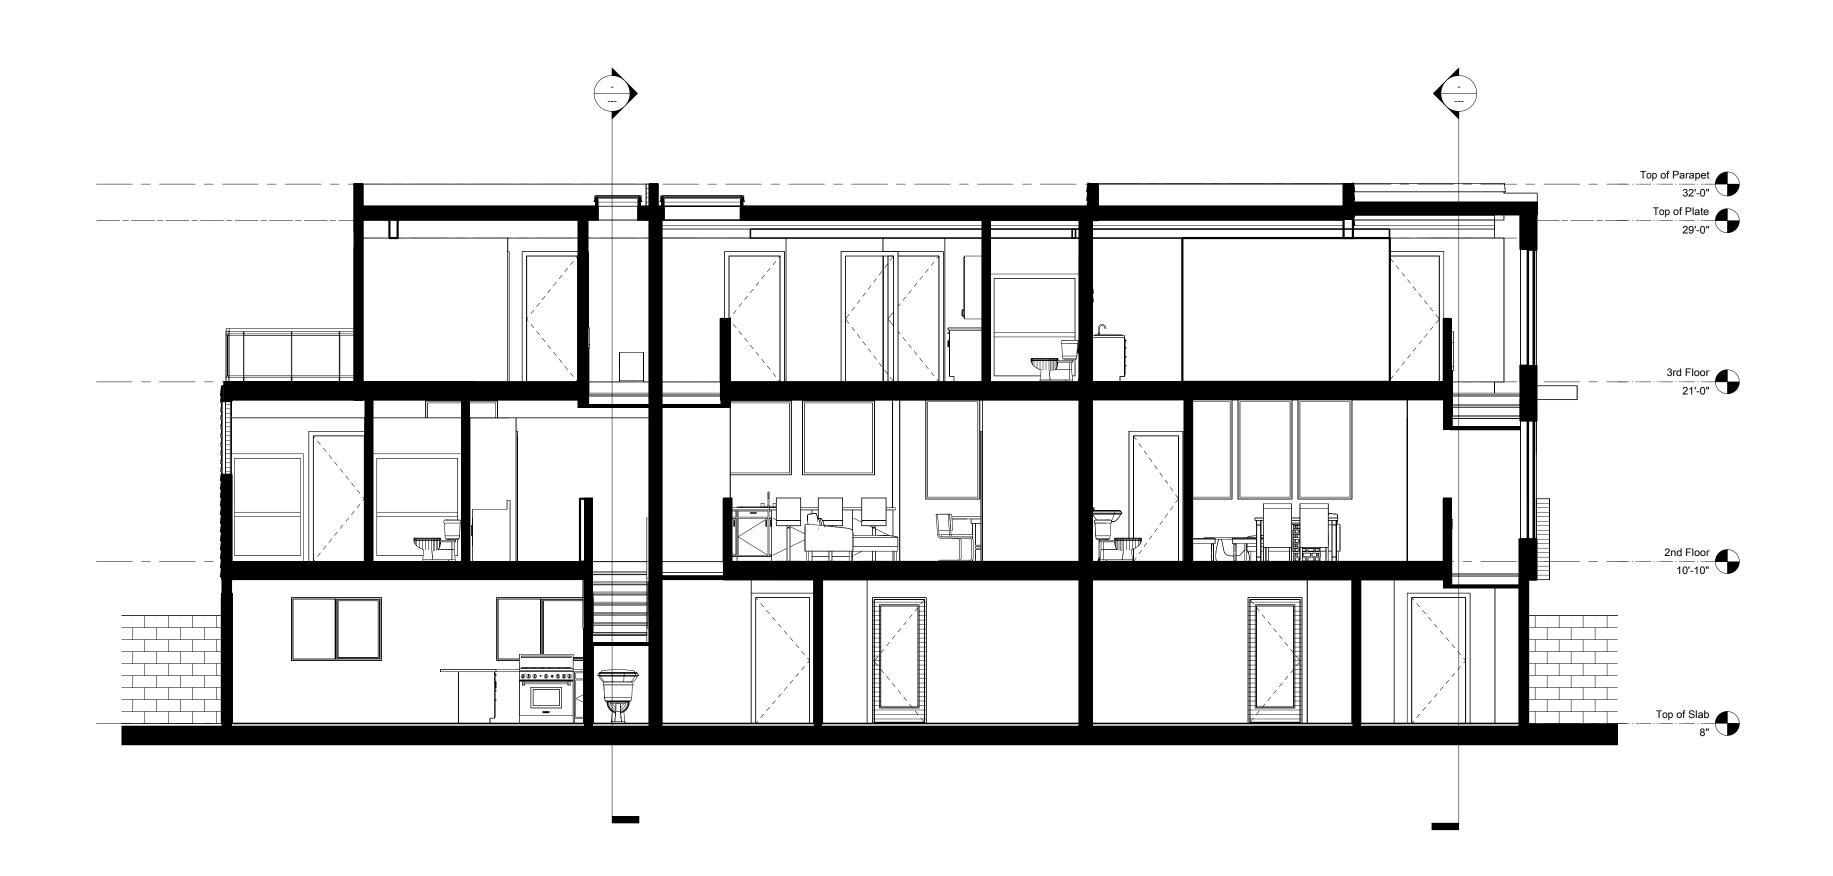

NORTH (LEFT) ELEVATION

EAST (REAR) ELEVATION





SOUTH (RIGHT) COMMON DRIVE ELEVATION





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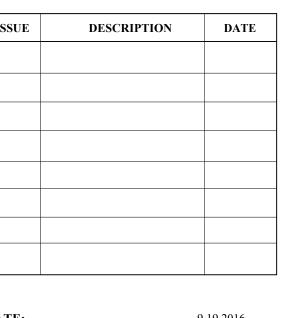
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# DOYLE STREET MEWS

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### ELEVATIONS RENDERINGS



DATE: 9.19.2016

JOB NO. 16.000

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SHEET NO. EXHIBIT 1



NORTH (LEFT) COMMON DRIVE ELEVATION

# SOUTH VIEW ON DOYLE STREET



NORTHWEST STREET RENDERING

# NORTH VIEW ON DOYLE STREET



SOUTHWEST STREET RENDERING



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# DOYLE STREET MEWS

5876 & 5880 DOYLE ST. EMERYVILLE, CA 94608

# CONTEXT RENDERINGS

ISSUE	DESCRIPTION	DATE

DATE:
JOB NO.
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EXHIBIT 2

SHEET NO.

### Family-Friendly Design Guidelines, Site and Building Design

FFD ID	Guideline description	How we are addressing it
J-41	Provide units with two, three or more bedrooms.	Of the six residences, two are 2BR, and four are 3BR
J-42	In high density housing, include a variety of unit types.	Mix of 2BR and 3BR unit types.
J-43	Place and configure units to relate well to quiet and noisy streets, on-site open space and each other, as shown in the Unit Adjacency Diagram.	n/a
J-44	Situate as many family-oriented units as possible adjacent to open spaces designed and landscaped to create active play areas and opportunities for gathering and quiet respite.	All six residences are in close proximity to landscaped, quiet, play/gathering areas.
J-45	Provide ample exterior play areas that are safe and visible from major spaces in homes, with a variety of age-appropriate equipment.	(Same comment as J-44)
J-46	Design visible places where pre-teens and teens will want to gather.	(Same comment as J-44)
J-47	In larger projects (e.g. over a hundred units), consider dividing the project into smaller communities centered around open space, where residents have exclusive access to their common and circulation areas.	n/a
J-48	Designate parking for family-friendly units near hallways and elevators.	Parking spaces are located below each respective residence.
J-49	Provide more bicycle parking than the code requires, with space for longer family bicycles and trailers.	Seven bike parking spaces required by code; fourteen are provided.
J-50	Provide ample in-unit or common laundry areas. In-unit laundry facilities are preferred in units with three or more bedrooms.	All six residences have in-unit laundry facilities.

### Family-Friendly Design Guidelines, Unit Design

FFD ID	Guideline description	How we are addressing it
J-51	Front doors should not enter directly into a room, but rather should enter into a transitional space, which could be an enclosed foyer.	All residences' front doors enter into a transitional space.
J-52	Provide indoor space near the entry for tricycles, strollers, outdoor toys, etc., where parked items will not obstruct circulation.	Storage area underneath stairs will be able to accommodate strollers & outdoor toys.
J-53	Provide only one master suite. Other bedrooms should have access to a common bathroom. In three-bedroom units provide at least two full bathrooms.	3BR residences have only one master suite, and 2.5 bathrooms.
J-54	Separate sleeping areas from living areas. In two-level units, place bedrooms on a separate floor from living areas.	Bedrooms are on the third floor, living areas are on the second floor.
<b>J-55</b> (a)	Provide each bedroom with access to a full bathroom without going through the living room, dining room or kitchen.	DONE
<b>J-55</b> (b)	Provide a bathtub in the unit.	DONE
<b>J-55</b> (c)	In multi-level units, provide at least a half bath on the floor with the living room, dining room and kitchen.	DONE
<b>J-56</b> (a)	The dining area should have enough room for a family-sized dining table with all household members seated around it, plus circulation.	See pages A204 & A205 (Unit A/B/C Furniture Plans) in plan set.
<b>J-56</b> (b)	The living area should also have enough room for seating for all household members plus other furniture and circulation.	See pages A204 & A205 (Unit A/B/C Furniture Plans) in plan set.
J-57	In units near play areas, provide windows that allow for supervision of children outdoors.	East (Rear) Elevation on Exhibit 1 shows that the two easternmost residences have windows looking towards the two large open spaces.
J-58	Hallways in units should be well lighted and wide enough for children to play in.	Hallways will have recessed lighting in the ceiling.
J-59	Provide space that can change use as children grow, such as from toddler play to homework to music making to gathering.	1st floors have flexible bonus rooms. 2nd floors have open, flexible layouts.
J-60	For units with other units below, provide soundproofing between ceilings and floors with an Impact Insulation Classification that is above the Building Code requirement, except under kitchens and bathrooms.	n/a
J-61	Design units with infant and toddler safety in mind (e.g. stairs that easily accept toddler gates, no glass room dividers, and ability to add child safety devices or window locks to prevent toddlers from climbing out of windows).	Residences will easily accept toddler gates at the stairs, child safety devices in kitchens and bathrooms, child window locks, electrical outlet covers, etc.






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# DOYLE STREET MEWS

5876 & 5880 DOYLE ST. EMERYVILLE, CA 94608

# FAMILY FRIENDLY DESIGN

ISSUE	DESCRIPTION	DATE

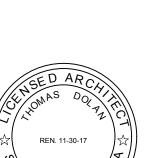
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EXHIBIT 3

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# DOYLE STREET MEWS

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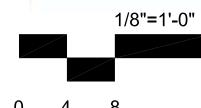
# Landscape Plan

ISSUE	DESCRIPTION	DATE

1 1

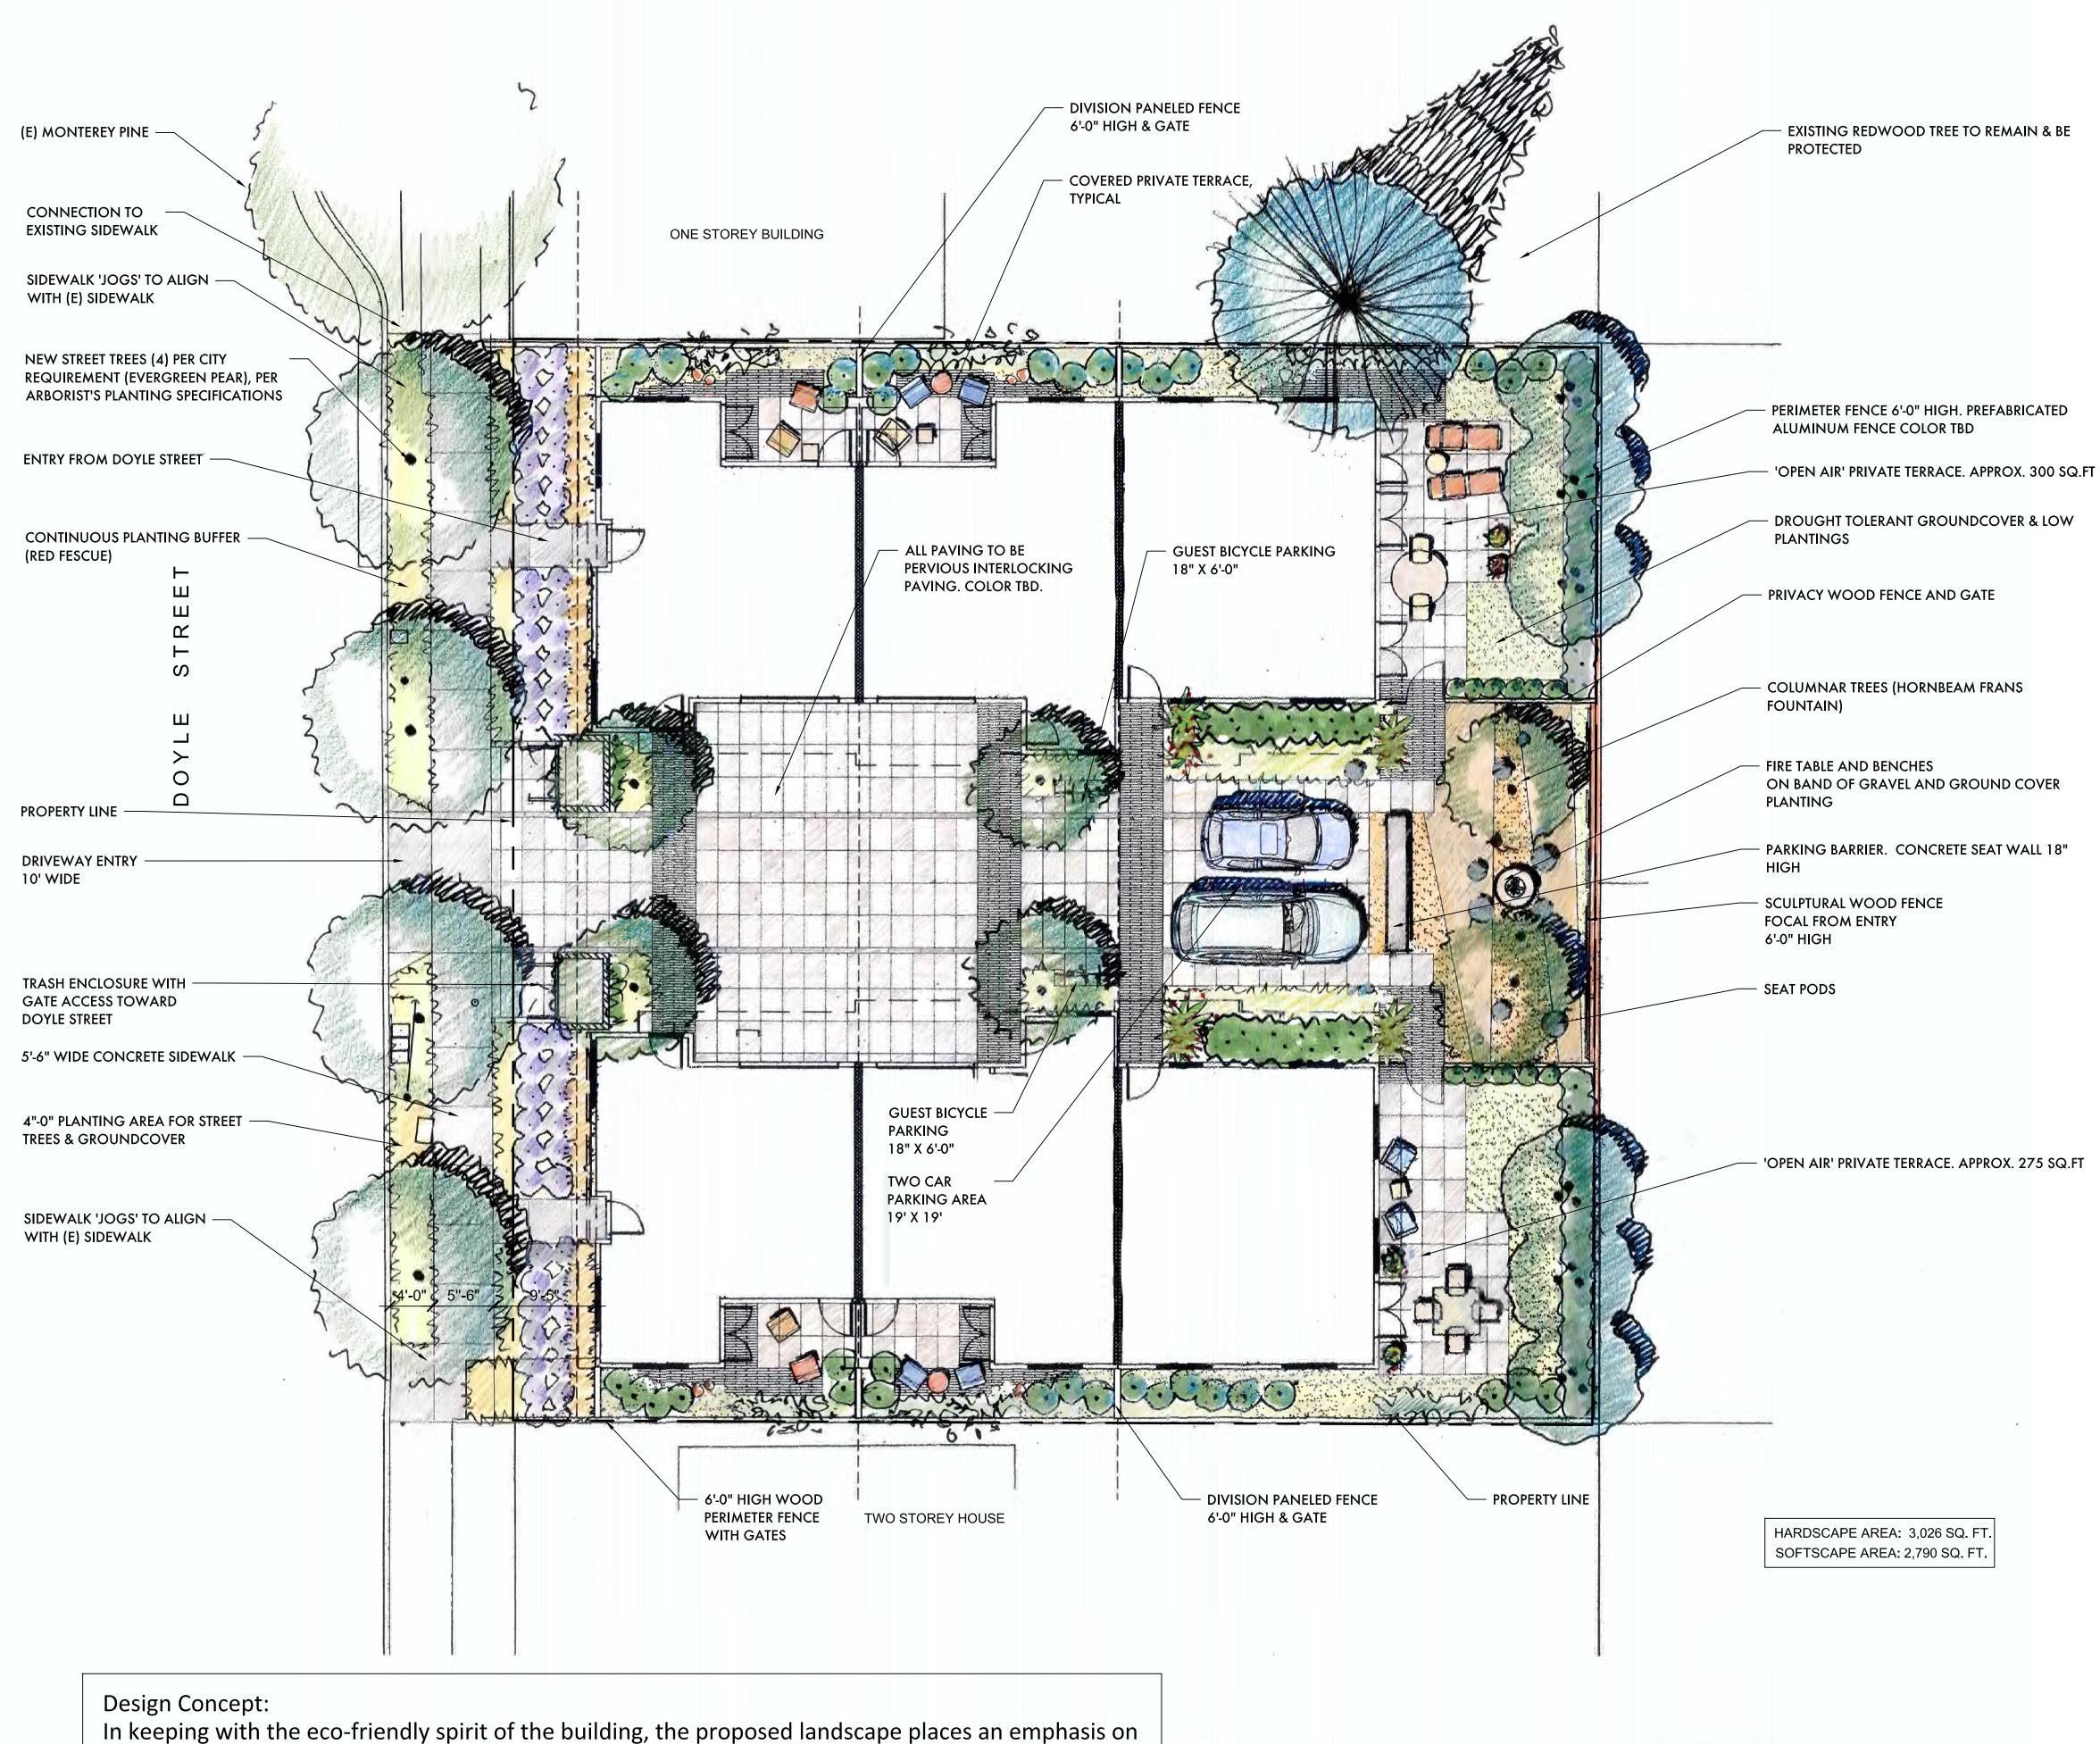SHEET






In keeping with the eco-friendly spirit of the building, the proposed landscape places an emphasis on native & drought tolerant plantings. Additionally, low groundcover & shrub species are specified to receive sheet run-ff and downspout drainage. In an effort to retain run-off on-site & recharge the aquifer, permeable pavings are used throughout the property.

#### Plant List

Botanical Name	Common Name	Size	Spacing	Notes
Carpinus betulus 'Frans	European	24" box	As shown	Columnar tree at Mews
Fontaine'	Hornbeam			
Pyrus kawakamii	Evergreen pear	24" box	As shown	Proposed street tree at Doyle -to match (e) to
Shrubs				
Botanical Name	Common Name	Size	Spacing	
Arctostaphylos 'Emerald Green'	Manzanita groundcover	1 gal	8'-0"	Native, evergreen groundcover
Calamagrostis x acutiflora 'Karl Foerster	Feather reed grass	1 gal	2'-0"	
Carex divulsa	Berkeley sedge	1 gal	2'-0"	Drought tolerant groundcover that can acc drainage
Ceanothus 'Dark Star'	Wild lilac	1 gal	5'-0"	Native, accent entry shrub
Cordyline 'Electric Pink'	NCN	1 gal	As shown	
Hydrangea macrophyla	Blue hydrangea	5 gal	As shown	Shade tolerant color
Hydrangea quercifolia	Oakleaf hydrangea	5 gal	As shown	Shade tolerant color
Lavandula augutifolia	English lavender	1 gal	2'-6"	Drought tolerant shrub that provides color texture
Loropetalum chinense var. rubrum 'Burgundy'	- Red Fringe Flower	5 gal	4'-0"	Shade tolerant color
Mimulus aurantiacus	Monkey flower	1 gal	3'-0"	Native flora
Myrica californica	Pacific wax myrtle	5 gal	8'-0"	Native, evergreen screen
Pittosporum 'Silver Sheen'	NCN	5 gal	4'-0"	Evergreen screen
Groundcover				
Botanical Name	Common Name	Size	Spacing	Notes
Thyme	NCN	Flats	18"	Groundcover for private residents
Heuchera hybrids "Berry Marmalade'	Coral bells	1 gal	18"	Native, shade tolerant color
Isotoma fluviatilis	Blue star creeper	Flats	12"	Groundcover between concrete steppers
Festuca rubra	Creping fecue	sod		Ground plane along sidewalk and entry, accepts drainage

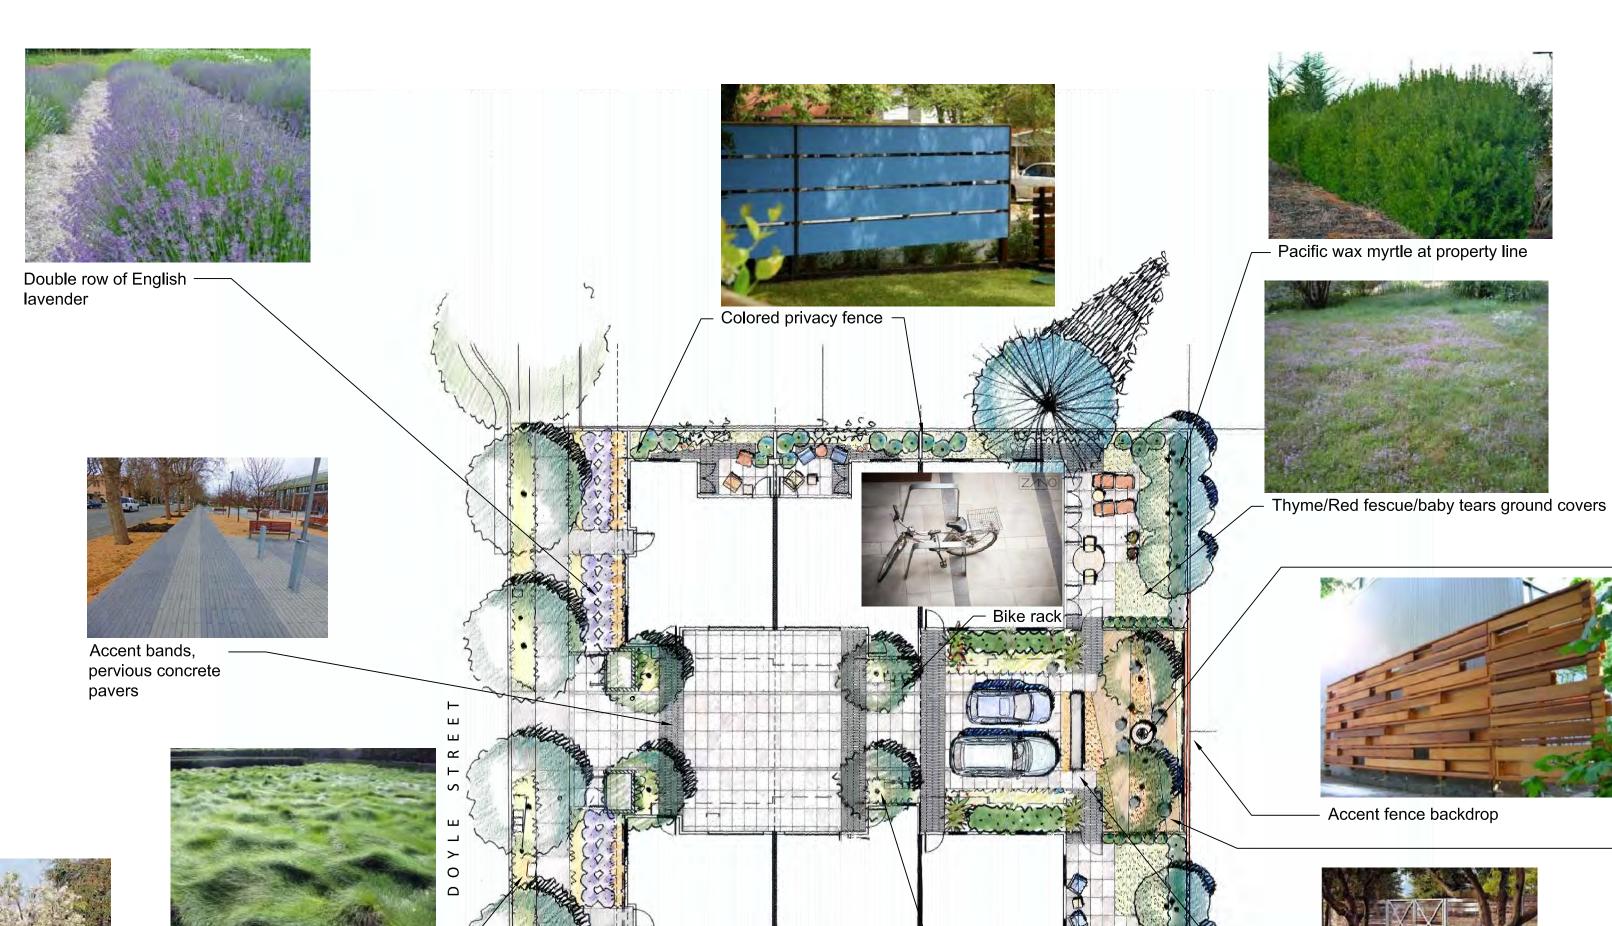

Evergreen pear street tree (to match existing street trees) planted in structural soil per Project Arborist's specifications No-mow fescue both sides of -

sidewalk improvements

English lavender & reed

#### Notes:


Existing site conditions, trees and topography are based upon a survey prepared by American Baseline Company, dated November 2016, and are assumed to be accurate.

This plan is schematic and not meant for construction.

All proposed plantings shall be watered by an automatic irrigation system compliant with the city of Emeryville's specifications. The system shall utilize a rain sensor and trees will be separately valved

#### **Arborist Notes**

- 1. Neighboring redwood tree to be protected throughout length of project.
- 2. Project arborist (PA) to hold pre-construction meeting prior to the commencement of any site disturbances.
- 3. PA to perform or supervise an exploratory roots search, via airspade, at the proposed location of the building foundation. The foundation design shall be 'flexible' in that the footing may 'bridge' existing roots to keep them intact. Any root pruning shall be determined and executed by, and only by, the PA.
- 4. Once roots are exposed, PA to determine if structural soil will benefit the foundation design and root health of the tree.

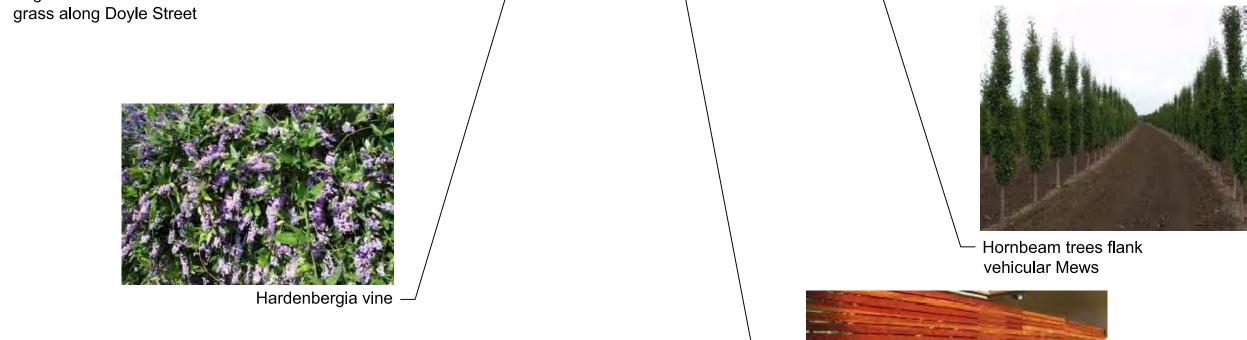



Espalier tree








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CLIENT:

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JAKE AFTERGOOD WELLSWORTH INVESTMENT 319 S. Robertson Blvd. Beverly Hills, CA 90211

Gas fire pit

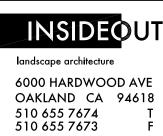Seat pods at fire pit

#### CONSULTANTS:

SURVEY AMERICAN BASELINE COMPANY 897 Northrup St. Ste. #7 San Jose, CA95126 408.394.9281

> **LANDSCAPE** INSIDE OUT 6000 Harwood Avenue Oakland CA 94618 510.655.7674

### DOYLE STREET **MEWS**

5876 & 5880 DOYLE ST. EMERYVILLE, CA 94608

# Landscape imagery

ISSUE	DESCRIPTION	DATE	

9.23.2016 SHEET

